#

WASH STABILIZATION IMPROVEMENTS

CITY PROJECT: B25-PW-105009-500599

	DRAWING INDEX				
SHEET NUMBER	R SHEET DESCRIPTION SHEET TITLE				
01	CV01	COVER SHEET			
02	GN01	GENERAL NOTES			
03	GC01	GEOMETRIC CONTROL SHEET			
04	TS01	TYPICAL SECTIONS			
05	TS02	TYPICAL SECTIONS			
06	PL01	WASH PLAN & PROFILE STA 16+00 TO 20+00			
07	PL02	WASH PLAN & PROFILE STA 20+00 TO 24+50			
08	PL03	WASH PLAN & PROFILE STA 24+50 TO 28+00			
09	DT01	GRADING DETAIL			
10	ST01	STRUCTURE NOTES AND DETAILS			
11	ST02	STRUCTURE DETAILS			

BASIS OF HORIZONTAL CONTROL

BASIS OF HORIZONTAL CONTROL:

JOB SETTINGS:

HORIZONTAL DATUM: NAD83 (CORS96)

ARIZONA STATE PLANE WEST (SPC AZ WEST)

LINEAR UNITS: US FOOT COORDINATE: GROUND

GEOID: GEOID 2012BU ZONE 5

LOCAL PROJECT CONTROL:

CONTROL POINT NO. 506522 N. = 1274592.1800 E. = 518977.1800 ELEV. = 573.33PROJECT WAS ADJUSTED GRID TO GROUND BASED POINT 506522 AS THE ORIGIN POINT WITH A COMBINED SCALE FACTOR OF 1.000065913991 AND ZERO ROTATION.

CONTROL POINT NO. 506524

N. = 1274762.7100 E. = 519355.6900 ELEV. = 590.25

CONTROL POINT NO. 506525

N. = 1274720.7700 E. = 518532.0400 ELEV. = 564.39

CONTROL POINT NO. 506526

N. = 1274477.1300 E. = 517264.1500 ELEV. = 514.07

CONTROL POINT NO. 506945

N. = 1274373.6600 E. = 517686.2200 ELEV. = 528.44


GROUND BEARING AND DISTANCE BETWEEN CONTROL POINT 506526 AND 506524:

N82°13'30" E 2110.95'



PREPARED BY:

Kimley » Horn

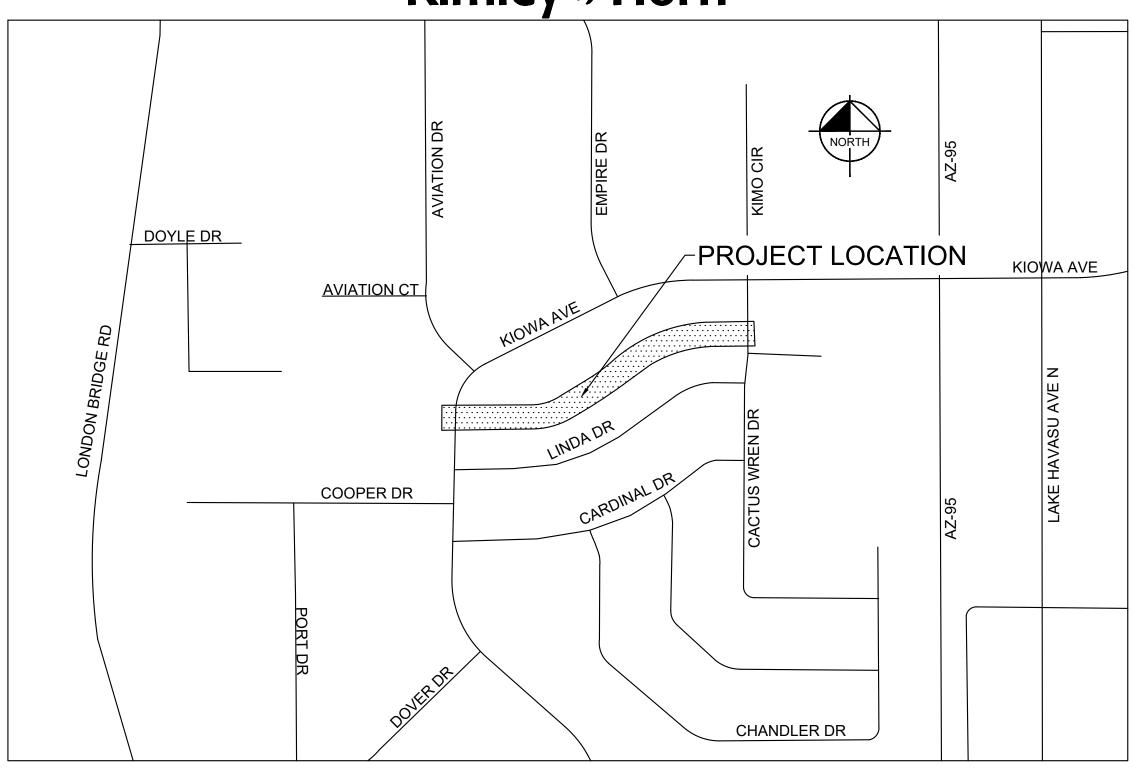

LOCATION MAP SCALE: N.T.S.

PROJECT ENGINEER

KIMLEY-HORN 1661 E CAMELBACK RD #400, PHOENIX, AZ 85016 PHONE: 602-944-5500

CONTACT: ZACHARY SCHMIDT, P.E. NANCY CAMPBELL

CAL SHEEHY MICHELE LIN JENI COKE JIM DOLAN CAMERON MOSES DAVID DIAZ

VICE MAYOR COUNCIL MEMBER

PROJECT MANAGER

SHAWN CLARKE, P.E.

UTILITY CONTACTS

LAKE HAVASU CITY (WASTEWATER)

LAKE HAVASU CITY

(WATER)

SUDDEN LINK

FRONTIER COMMUNICATION

UNISOURCE ENERGY SERVICES (928) 505-7002

UNISOURCE ENERGY SERVICES (928) 505-7002 (ELECTRIC)

(928) 855-3999

(928) 855-2618

(928) 855-9855

(928) 358-1977

CITY COUNCIL

MAYOR COUNCIL MEMBER COUNCIL MEMBER COUNCIL MEMBER COUNCIL MEMBER

CONTRACTOR TO CALL BLUE STAKE AND POTHOLE PRIOR TO EXCAVATION RIZONA BLUE STAKE CALL TWO WORKING DAYS BEFORE YOU DIG
Dial 811 or 602-263-1100 1-800-STAKE-IT (OUTSIDE MARICOPA COUNTY)



Sheet Number: **CV01**

Sheet 1 of 11

A. GENERAL


- 1. ALL STRUCTURES ARE DESIGNED TO ACT AS A STRUCTURAL UNIT UPON COMPLETION. CONTRACTOR SHALL DESIGN AND PROVIDE NECESSARY BRACING, TEMPORARY SUPPORTS, AND SHORING TO RESIST FORCES ON THE STRUCTURE DURING CONSTRUCTION.
- 2. VERIFY ALL DIMENSIONS AND ELEVATIONS PRIOR TO STARTING WORK. NOTIFY THE ENGINEER OF ANY DISCREPANCIES.
- 3. VERIFY LOCATIONS OF ALL EXISTING UTILITIES PRIOR TO STARTING WORK.
- 4. CONTRACTOR SHALL EXERCISE EXTREME CARE DURING THE EXCAVATION AND CONSTRUCTION FOR NEW STRUCTURES TO AVOID DAMAGE TO EXISTING STRUCTURES AND EXISTING UTILITIES. CONTRACTOR IS RESPONSIBLE FOR PROVIDING ALL MEANS AND METHODS REQUIRED TO FACILITATE CONSTRUCTION OF THE WORK AND ENSURING THE SAFETY, STABILITY AND INTEGRITY OF ADJACENT STRUCTURES AND FACILITIES.
- 5. THE ENGINEER SHALL BE NOTIFIED A MINIMUM OF 24 HOURS PRIOR TO BEGINNING ANY CONSTRUCTION.
- 6. ANY WORK PERFORMED WITHOUT THE KNOWLEDGE AND APPROVAL BY THE ENGINEER AND/OR ALL WORK MATERIAL NOT IN CONFORMANCE WITH THE PLANS AND SPECIFICATIONS IS SUBJECT TO REMOVAL AND REPLACEMENT AT THE CONTRACTOR'S EXPENSE.
- 7. NO JOB WILL BE CONSIDERED COMPLETE UNTIL ALL CURBS, PAVEMENT AND SIDEWALKS (NEW AND EXISTING) HAVE BEEN SWEPT CLEAN OF ALL DIRT AND DEBRIS.
- 8. ALL QUANTITIES SHOWN ON PLANS ARE APPROXIMATE, ARE NOT VERIFIED BY THE ENGINEER, AND ARE FURNISHED SOLELY FOR THE CONTRACTOR'S CONVENIENCE. THEY DO NOT NECESSARILY CORRESPOND TO BID SCHEDULE ITEMS. PAYMENT WILL BE BASED ON BID SCHEDULE ITEMS. THE CONTRACTOR SHALL NOT BE RELIEVED OF HIS RESPONSIBILITY FOR INDEPENDENTLY ESTIMATING WORK QUANTITIES PRIOR TO BIDDING.
- 9. BACKFILL COMPACTION SHALL BE PER MAG 301, UNLESS OTHERWISE NOTED.
- 10. REMOVAL OF STRUCTURES AND OBSTRUCTIONS AS NECESSARY TO COMPLETE THE WORK, OTHER THAN SPECIALLY SCHEDULED IN THE BID, IS INCIDENTAL TO THE CONTRACT. NO SEPARATE MEASUREMENT OF PAYMENT FOR UNSCHEDULED REMOVAL ITEMS WILL BE MADE.
- 11. CONSTRUCTION STAKING SHALL BE BY THE CONTRACTOR'S SURVEYOR WITH CONTROL PROVIDED BY THE DESIGN ENGINEER WHO STAMPED THE PLANS.
- 12. THE LAKE HAVASU CITY MAY ORDER ANY OR ALL WORKMANSHIP AND MATERIALS TO BE TESTED ACCORDING TO APPLICABLE STANDARDS.
- 13. THE CONTRACTOR WILL BE RESPONSIBLE FOR ALL REWORK AND/OR REMOVAL AND REPLACEMENT OF ALL MATERIALS AND/OR WORKMANSHIP REPRESENTED BY A FAILING TEST.
- 14. THE CONTRACTOR WILL BE RESPONSIBLE FOR ALL COSTS OF TESTING AND QUALITY ASSURANCE/QUALITY CONTROL AS DELINEATED IN THE CITY'S PROJECT SPECIFICATIONS. THE COST OF TESTING IS INCIDENTAL TO EACH ITEM OF WORK. THE CONTRACTOR SHALL ALSO BE RESPONSIBLE FOR THE COST OF ANY CITY INSPECTION AND CITY INSPECTION TIME IF THE CONTRACTOR'S WORK IS BEING PERFORMED IN OVERTIME, AT NIGHT, OR ON WEEKENDS.
- 15. APPROVAL OF A PORTION OF THE WORK IN PROGRESS DOES NOT GUARANTEE ITS FINAL ACCEPTANCE. TESTING AND EVALUATION MAY CONTINUE UNTIL WRITTEN FINAL ACCEPTANCE OF A COMPLETE AND WORKABLE UNIT.
- 16. THE LAKE HAVASU CITY MAY SUSPEND THE WORK BY WRITTEN NOTICE WHEN, IN ITS JUDGEMENT, PROGRESS IS UNSATISFACTORY, WORK BEING DONE IS UNAUTHORIZED OR DEFECTIVE, WEATHER CONDITIONS ARE UNSUITABLE, OR THERE IS A DANGER TO THE PUBLIC HEALTH OR SAFETY.
- 17. CLEARING AND GRUBBING IS CONSIDERED INCIDENTAL TO THE WORK UNLESS SEPARATELY IDENTIFIED IN THE BID SCHEDULE. NO SEPARATE MEASUREMENT OF OR PAYMENT FOR CLEARING, GRUBBING, AND TREE REMOVAL WILL BE MADE. THE SITE OF ALL EXCAVATION, EMBANKMENTS, AND FILLS SHALL FIRST BE CLEARED OF STUMPS, TRASH, WEEDS, RUBBISH, AND LOOSE BOULDERS WHICH SHALL BE REMOVED AND DISPOSED OF. THE CONTRACTOR MUST SATISFY HIMSELF REGARDING THE CHARACTER AND AMOUNT OF LOAM, CLAY, SAND, QUICKSAND, HARDPAN, GRAVEL, ROCK, WATER, AND ALL OTHER MATERIAL TO BE ENCOUNTERED AND WORK TO BE PERFORMED.
- 18. THE LOCATIONS OF ALL EXISTING UTILITIES SHOWN ARE APPROXIMATE AND ARE BASED ON FIELD DATA AND MAP RECORDS. THE CONTRACTOR SHALL CONTACT 1-800-STAKE-IT PRIOR TO ANY CONSTRUCTION ACTIVITY TO VERIFY THE ACTUAL LOCATION OF ALL UTILITIES. THE CONTRACTOR SHALL DETERMINE WHICH UTILITIES DO NOT PARTICIPATE IN 1-800-STAKE-IT AND CONTACT THEM DIRECTLY TO VERIFY THE LOCATION OF THOSE UTILITIES. ANY DAMAGE TO EXISTING UTILITIES CAUSED BY CONTRACTOR'S OPERATION SHALL BE REPORTED TO THE UTILITY OWNER IMMEDIATELY AND REPAIRED OR REPLACED AT NO COST TO THE CITY. IN CASES WHEN THE EXISTING UTILITIES ARE NOT AS DEPICTED ON THE PLANS SOME MINOR DEVIATION TO THE PROPOSED ALIGNMENT MAY BE ALLOWED TO MAINTAIN MINIMUM SEPARATION DISTANCES BETWEEN UTILITIES. ANY PROPOSED TO MAINTAIN MINIMUM SEPARATION DISTANCES BETWEEN UTILITIES. TO THE ALIGNMENT MUST BE SUBMITTED TO THE CITY'S REPRESENTATIVE FOR REVIEW. NO CHANGES WILL BE ALLOWED WITHOUT PRIOR APPROVAL.
- 19. THE CONTRACTOR SHALL LIMIT THE WORK AREA TO PUBLIC RIGHT-OF-WAY AND PERMANENT EASEMENTS AS SHOWN FOR CONSTRUCTION OF THE PROJECT. TEMPORARY CONSTRUCTION EASEMENTS EXIST AS SHOWN AND INDICATED IN THE PLANS.
- 20. CONTRACTOR SHALL OBTAIN ANY ADDITIONAL TEMPORARY EASEMENTS OR USE AGREEMENTS THAT ARE DEEMED NECESSARY FOR CONSTRUCTION AT NO ADDITIONAL COST TO THE CITY. COPIES OF ALL CONTRACTOR OBTAINED EASEMENTS AND USE AGREEMENTS SHALL BE PROVIDED TO THE CITY'S REPRESENTATIVE PRIOR TO THE UTILIZATION OF THE SITE.
- 21. THE CONTRACTOR SHALL GRADE AND RESURFACE ALL AREAS DISTURBED BY CONSTRUCTION, INCLUDING LANDSCAPE ROCK, IN ACCORDANCE WITH THE SPECIFICATIONS AND TO A CONDITION EQUAL TO, OR BETTER THAN, THE PRE—CONSTRUCTION CONDITION.
- 22. THE CONTRACTOR SHALL PROTECT ALL CONCRETE STRUCTURES TO REMAIN. ALL CONCRETE REPLACEMENT SHALL BE FROM JOINT TO JOINT (WALLS, SIDEWALK) AND SHALL BE REPLACED WITH 4000 PSI CONCRETE. ALL DAMAGED CONCRETE PANELS MUST BE REPLACED AND SHALL BE THE RESPONSIBILITY OF THE CONTRACTOR.
- 23. THE CONTRACTOR SHALL PROVIDE PROTECTION TO PREVENT UNDERMINING OR DAMAGING THE STRUCTURAL INTEGRITY OF ALL FENCES, RETAINING WALLS, STREET SIGNS, OTHER UTILITY POLES, OR OTHER PRIVATE OR PUBLIC IMPROVEMENTS WITHIN THE PROJECT AREA. THE CONTRACTOR SHALL MAKE ARRANGEMENTS WITH THE OWNING UTILITY AS NECESSARY TO PROVIDE TEMPORARY SUPPORT, OR PROTECTION DURING CONSTRUCTION WORK, AND SHALL NEATLY REMOVE AND PROMPTLY REPLACE NON UTILITY IMPROVEMENTS WITHOUT UNDUE DISRUPTION. THE COST OF ALL SUCH PROTECTION, REMOVAL, AND REPLACEMENT REQUIRED TO COMPLETE THE PROJECT SHALL BE SUBSIDIARY TO OTHER BID ITEMS.
- 24. THE CONTRACTOR SHALL REMOVE ALL FENCING, ASPHALT AND CONCRETE ROADS AND DRIVEWAYS, CURB AND GUTTER, RIP—RAP, DRAINAGE CULVERTS AND ASSOCIATED APPURTENANCES AS REQUIRED FOR CONSTRUCTION PURPOSES. ALL ITEMS DAMAGED OR REMOVED SHALL BE RESTORED IN ACCORDANCE WITH THE SPECIFICATION TO A CONDITION EQUAL TO, OR BETTER THAN, THEIR CONDITION PRIOR TO THE START OF THE PROJECT. ITEMS OF WORK NOT SPECIFICALLY INCLUDED IN THE MEASUREMENTS AND PAYMENT SECTION OF THE SPECIFICATIONS SHALL BE CONSIDERED SUBSIDIARY TO OTHER BID ITEMS AND SHALL NOT BE PAID FOR SEPARATELY.
- 25. IT IS NOT THE INTENTION OF THE SPECIFICATIONS TO SUPERSEDE ANY FEDERAL, STATE OR LOCAL LAWS, REGULATIONS AND/OR ORDINANCES; THEY SHALL GOVERN IN ALL INSTANCES. IT IS THE CONTRACTOR'S RESPONSIBILITY TO SHOW A GOOD FAITH EFFORT AND TO PROTECT ALL EXISTING UTILITY TIES AND STRUCTURES AND TO ABIDE BY ALL FEDERAL, STATE AND LOCAL LAWS AND ORDINANCES IN THIS RESPECT.
- 26. THE CONTRACTOR SHALL PROTECT ALL EXISTING IMPROVEMENTS ON PRIVATE PROPERTY. ALL ITEMS DAMAGED OR REMOVED SHALL BE RESTORED IN ACCORDANCE WITH THE SPECIFICATION TO A CONDITION EQUAL TO, OR BETTER THAN, THEIR CONDITION PRIOR TO THE START OF THE PROJECT.
- 27. PROPERTY LINES SHOWN ON DRAWINGS ARE APPROXIMATE.

- 28. ALL CONSTRUCTION SHALL CONFORM TO THE LATEST MARICOPA ASSOCIATION OF GOVERNMENTS, UNIFORM STANDARD SPECIFICATIONS AND DETAILS FOR PUBLIC WORKS CONSTRUCTION (MAG). OTHER CITY'S, AND ADOT DETAILS (AS CITED IN PROJECT PLANS AND SPECIFICATIONS), LAKE HAVASU CITY STANDARD DETAILS WILL CONTINUE TO APPLY WHERE SUCH DETAILS WERE NOT ADOPTED OR INCLUDED BY MAG. ALTERNATE DETAILS AND SPECIFICATIONS MAY BE SUBMITTED FOR REVIEW AND ACCEPTANCE BY THE ENGINEERING DIVISION. IF ACCEPTED, ALTERNATE DETAILS WILL BE SHOWN AS PART OF THE APPROVED PLANS/DETAIL SHEETS.
- 29. THIS SET OF PLANS HAS BEEN REVIEWED FOR COMPLIANCE WITH CITY REQUIREMENTS PRIOR TO ISSUANCE OF CONSTRUCTION PERMITS. HOWEVER, SUCH REVIEW SHALL NOT PREVENT THE CITY ENGINEER FROM REQUIRING CORRECTION OF ERRORS OR OMISSIONS IN PLANS FOUND TO BE IN VIOLATION OF ANY LAW OR ORDINANCE.
- 30. APPROVAL BY THE CITY ENGINEER MEANS FOR GENERAL LAYOUT IN RIGHT—OF—WAY ONLY. CONSTRUCTION PERMITS SHALL BE OBTAINED WITHIN THIS PERIOD OR THE PLANS SHALL BE RESUBMITTED FOR APPROVAL. WORK SHALL ALSO BE CONTINUOUSLY PURSUED IN ORDER TO MAINTAIN A VALID PLAN APPROVAL AND PERMIT. APPROVAL IS ONLY FOR WORK WITHIN THE JURISDICTION OF LAKE HAVASU CITY.
- 31. AN APPROVED SET OF PLANS MUST BE AVAILABLE ON THE JOB SITE AT ALL TIMES. THE CONTRACTOR'S REPRESENTATIVE (CAPABLE OF COMMUNICATING WITH THE CITY'S REPRESENTATIVES) SHALL BE ON THE JOB AT ALL TIMES THE WORK IS BEING PURSUED.
- 32. THE CONTRACTOR IS RESPONSIBLE TO PROVIDE EMERGENCY TELEPHONE NUMBERS TO LAKE HAVASU CITY AT TIME OF LSSUANCE OF OFF——SLTE/ON——SITE PERMITS AND HAVE PERSONNEL AVAILABLE 24——HOURS A DAY TO RESPOND TO EMERGENCIES. IF THE CITY IS REQUIRED TO RESPOND AND MAKE EMERGENCY REPAIRS ON BEHALF OF THE CONTRACTOR, THE CONTRACTOR IS RESPONSIBLE TO REIMBURSE THE CITY FOR ALL COSTS INCURRED.
- 33. THE CONTRACTOR SHALL TAKE APPROPRIATE STEPS TO PREVENT EROSION AND DEPOSITION OF SEDIMENTS INTO WATER COURSES. THE CONTRACTOR SHALL SUBMIT AN EROSION CONTROL PLAN FOR APPROVAL, PRIOR TO THE START OF ANY EXCAVATION. ALL DRAINAGE PROTECTIVE DEVICES SUCH AS SWALES, INTERCEPTION DITCHES, PIPES PROTECTIVE BERMS, CONCRETE CHANNELS OR OTHER MEASURES DESIGNED TO PROTECT IMPROVEMENTS, WHETHER EXISTING OR PROPOSED, FROM RUNOFF OR DAMAGE FROM STORM WATER, MUST BE CONSTRUCTED PRIOR TO THE CONSTRUCTION OF ANY IMPROVEMENTS. ALL EROSION AND SEDIMENT CONTROL WORK SHALL BE INCIDENTAL TO OTHER PAY ITEMS.
- 34. TRAFFIC CONTROL SHALL CONFORM WITH THE TRAFFIC BARRICADE MANUAL AND MUTCD GUIDELINES. THE CONTRACTOR SHALL SUBMIT A TRAFFIC CONTROL PLAN PER THE TRAFFIC BARRICADE MANUAL. BARRICADES MUST BE CONTINUALLY MAINTAINED THROUGHOUT THE DURATION OF THE PROJECT. A TRAFFIC CONTROL PLAN (TCP) SHALL BE SUBMITTED TO THE ENGINEERING DIVISION AND ACCEPTED A MINIMUM OF 24——HOURS PRIOR TO CONSTRUCTION. AN ACCEPTED TCP WILL BE STAMPED AND A COPY RETURNED TO THE CONTRACTOR. A COPY OF THE ACCEPTED PLAN MUST REMAIN ON THE JOB SITE AT ALL TIMES.
- 35. ALL CONTRACTORS ARE RESPONSIBLE TO OBTAIN AN ARIZONA POLLUTANT DISCHARGE ELIMINATION SYSTEM (AZPDES) PERMIT IN ACCORDANCE WITH FEDERAL AND STATE REGULATIONS, INCLUDING NOTICE OF INTENT (NOI), NOTICE OF TERMINATION, AND STORM WATER POLLUTION PREVENTION PLAN (SWPPP). A COPY OF THE NOI AND SWPPP SHALL BE AVAILABLE ON THE JOB SITE AT ALL TIMES.
- 36. IT IS THE RESPONSIBILITY OF THE CONTRACTOR TO OBTAIN ANY AND ALL OTHER PERMITS AND MEET ANY REQUIREMENTS SET FORTH BY OTHER AGENCIES OR UTILITIES, WHICH HAVE JURISDICTION, AT THE CONTRACTORS EXPENSE, INCLUDING OSHA. CONTRACTOR SHALL MEET OSHA STANDARDS FOR TRENCH SAFETY.
- 37. FIRE ACCESS TO BE MAINTAINED DURING ALL PHASES OF CONSTRUCTION AS REQUIRED BY LAKE HAVASU CITY 38. FIRE DEPARTMENT.
- 39. THE CONTRACTOR SHALL KEEP SUITABLE EQUIPMENT ON HAND AT THE JOBSITE FOR MAINTENANCE DUST CONTROL, AND SHALL CONTROL DUST AS DIRECTED BY THE APPROPRIATE AGENCIES.
- 40. ALL EXISTING FLOW LINES SHOWN ARE APPROXIMATE AND SHALL BE FIELD VERIFIED BY CONTRACTOR.
- 41. PROPERTY LINES SHOWN ON DRAWINGS ARE APPROXIMATE.
- 42. THE CONTRACTOR SHALL GRADE AND RESURFACE ALL AREAS DISTURBED BY CONSTRUCTION, INCLUDING LANDSCAPE ROCK, IN ACCORDANCE WITH THE SPECIFICATIONS AND TO A CONDITION EQUAL TO, OR BETTER THAN, THE PRE-CONSTRUCTION CONDITION.
- 43. ANY ROCK ENCOUNTERED DURING EXCAVATION SHALL BE REMOVED AT NO ADDITIONAL COST TO THE CITY. ROCK EXCAVATION COST SHALL BE INCIDENTAL TO OTHER ITEMS OF WORK.
- 44. ANY SHORING REQUIRED SHALL BE CONSIDERED INCIDENTAL TO OTHER ITEMS OF WORK.
- 45. COORDINATE SHUTDOWN AND SEQUENCING REQUIREMENTS WITH OWNER 48——HOURS PRIOR TO CONSTRUCTION. THE CONTRACTOR MUST HAVE AN APPROVED SEQUENCING PLAN PRIOR TO ANY CONSTRUCTION.
- 46. CONTRACTOR SHALL BE RESPONSIBLE FOR ESTABLISHING STAGING AREAS FOR THEIR WORK.
- 47. CONTRACTOR SHALL FIELD VERIFY AND REPLACE ALL PROPERTY DRAIN PIPES (6" OR SMALLER, IN KIND) TO BE LAID OVER THE FINISHED GRADE SLOPE & EXTENDED 12" BEYOND TOP OF BANK PROTECTION AS SPECIFIED ON THE TECHNICAL SPECIFICATIONS (ALLOWANCE).

EARTHWORK QUANTITIES					
CUT (CY)	CUT (CY) FILL (CY) RIPRAP EXCAVATION (CY) MAINT. PATH BACKFILL (CY)		NET (CY)		
3193	3193 3524 3744 1218 2195				

- 1) EARTHWORK QUANTITIES ARE ESTIMATED VOLUMES USING NO CLEAR & GRUB LOSS, SHRINKAGE, COMPACTION, STRUCTURE ELEVATION, BULKING OR TOP SOIL HARVESTING FACTORS & SHALL BE FOR ESTIMATING & INFORMATION PURPOSES ONLY. THE CONTRACTOR SHALL PREPARE HIS OWN EARTHWORK ANALYSIS FOR BIDDING PURPOSES.
- 2) FILL QUANTITY DOES NOT ACCOUNT FOR SUITABILITY OF IN SITU MATERIAL.

LEGEND

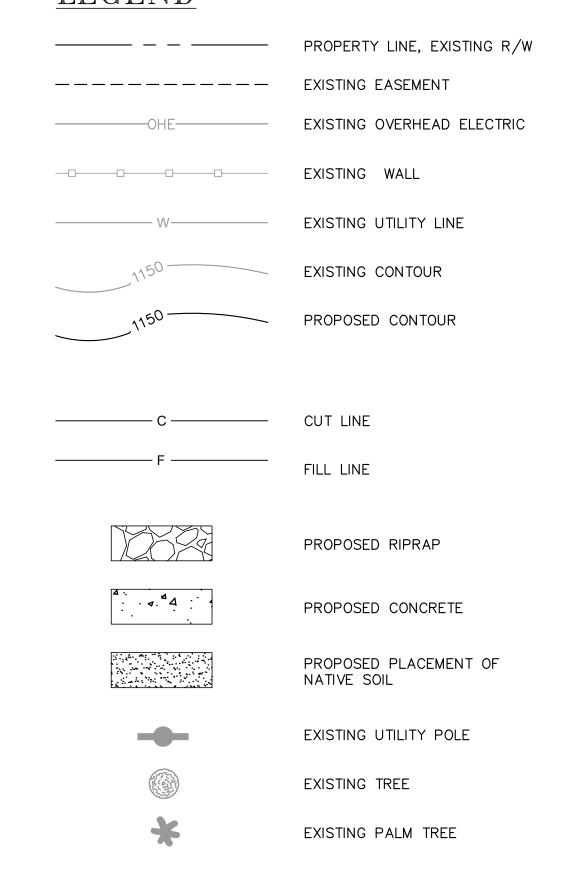

ABBREVIATIONS

ABBRI	EVIATIONS
AISC ASLD ASTM BF	AMERICAN INSTITUTE OF STEEL CONSTRUCTION ARIZONA STATE LAND DEPARTMENT AMERICAN SOCIETY FOR TESTING MATERIALS BACK FACE
BLDG	BUILDING
CLR	CLEAR
CONC	CONCRETE
CT	CONSTRUCTION
DIA	DIAMETER
DWG	DRAWING
E E E V	EAST, EASTING
ELEV	ELEVATION
ELC ESMT	ELECTRIC
EXST/EXIST	EASEMENT EXISTING
FF	FRONT FACE
FG	FINISH GRADE ELEVATION
FT	FOOT OR FEET
GND	GROUND
HW	HIGH WATER
JT	JOINT
LF	LINEAR FEET
LOL	LAYOUT LINE
LS	LUMP SUM
MAG	MARICOPA ASSOCATION OF GOVERNMENTS
MH	MANHOLE
N	NORTH, NORTHING
NIC	NOT-IN-CONTRACT NON-PAY ITEM
NPI NTS	NOT TO SCALE
OC	ON CENTER
PIP	PROTECT IN PLACE
PL	PROPERTY LINE
PROP	PROPOSED
S/W	SIDEWALK
SF	SQUARE FOOT
SPA	SPACING
SHT	SHEET BLU
SPEC	SPECIFICATIONS
SS	SANITARY SEWER
STA	STATION
STD	STANDARD

TEMPORARY CONSTRUCTION EASEMENT

© 2025 KIMLEY-HORN & ASSOCIATES, INC. 1661 E CAMELBACK RD #400, PHOENIX, AZ 85016 PHONE: 602-944-5500 | WWW.KIMLEY-HORN.COM

TOP OF FOOTING

TOP OF WALL

TCE

T/F



DATE	I	I	I	-
REVISIONS / SUBMISSIONS	I	I	_	-

CITY #3 PROVEMENTS

LAKE HAVASU CITY KIOWA DRAIN #3 WASH STABILIZATION IMPROVEI


Designed by: ZKS


Drawn by: ZJS

Checked by: ZRS

Date: 01/2025

SENERAL NOTES

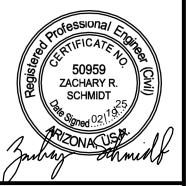

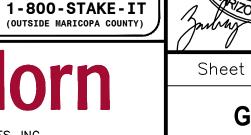

CONTRACTOR TO CAL

IE STAKE AND POTHOLE

ARIZONA BLUE STAKE

CALL TWO WORKING DAYS

Dial 811 or

602-263-1100


BEFORE YOU DIG

RIOR TO EXCAVATION

Sheet Number: **GN01**

Sheet 2 of 11



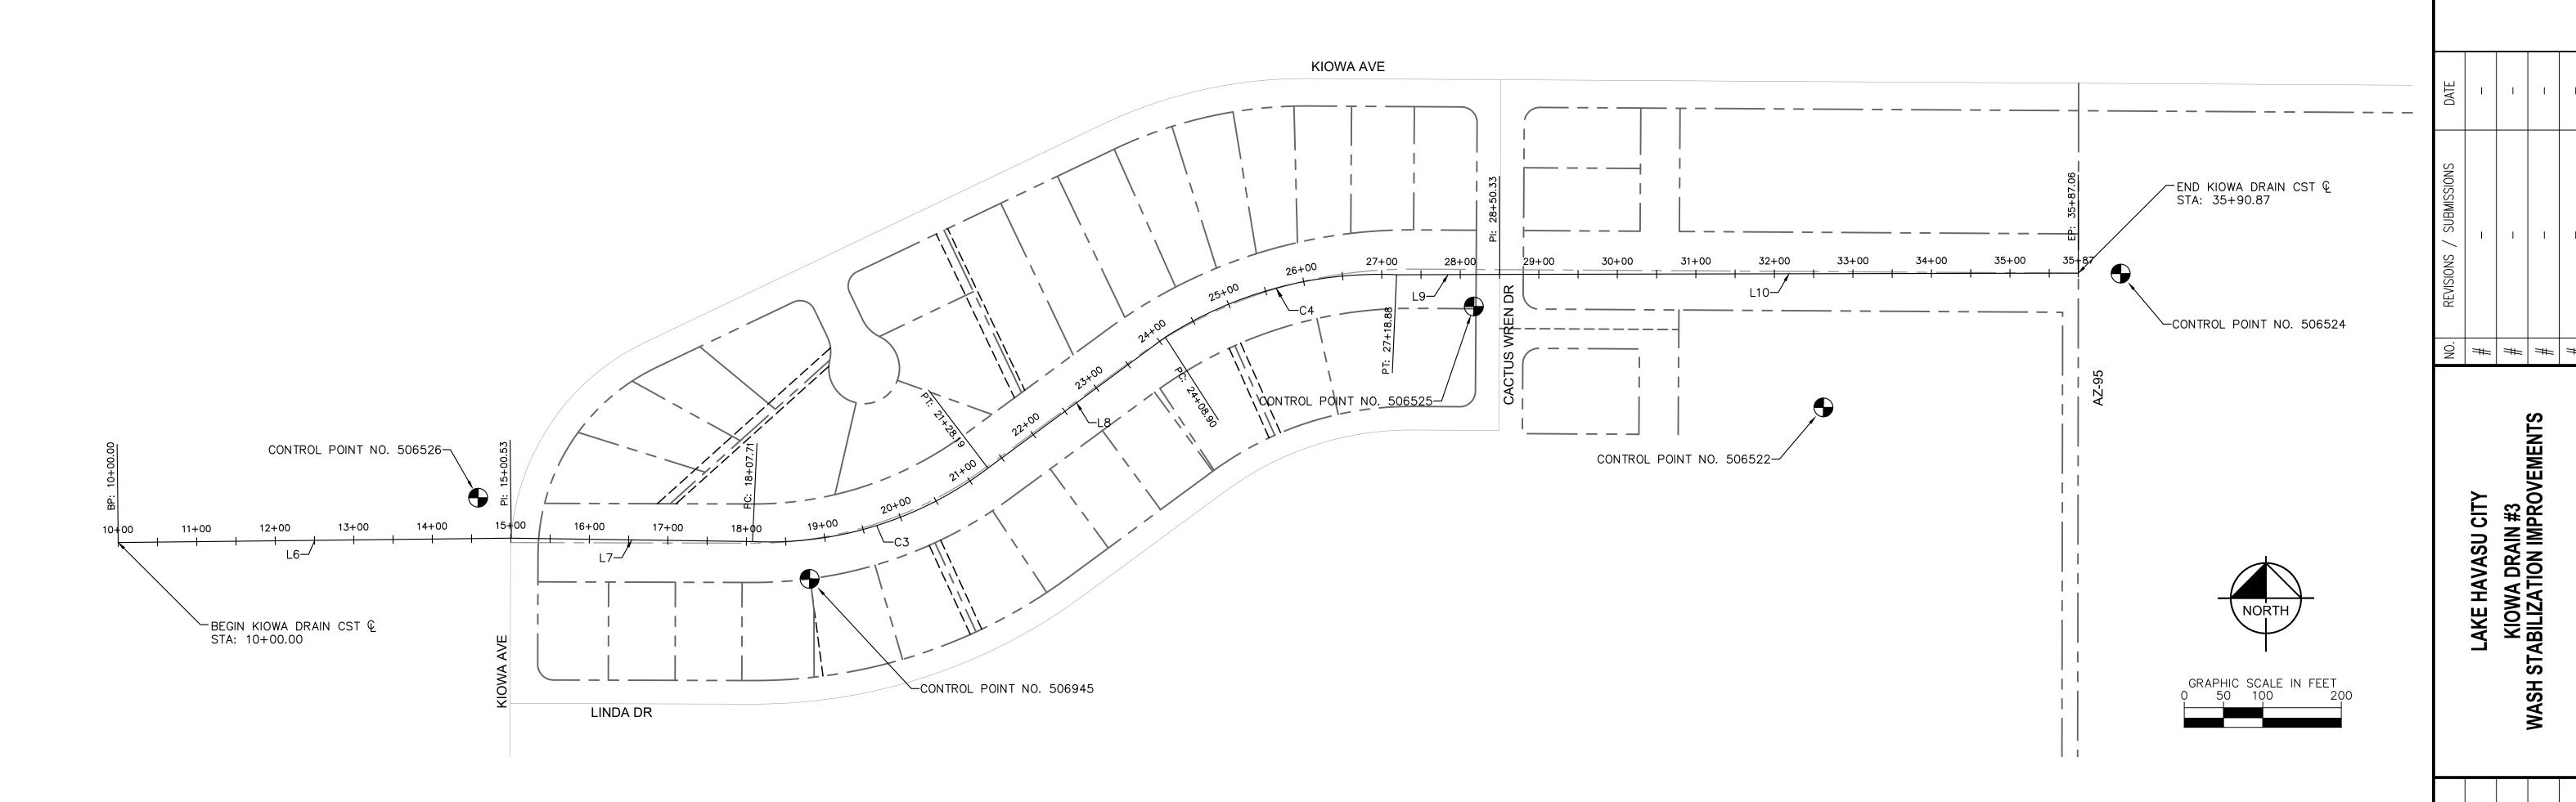

BASIS OF BEARING

BEARINGS SHOWN HEREON ARE BASED UPON U.S. STATE PLANE NAD83 COORDINATE SYSTEM ARIZONA STATE PLANE COORDINATE ZONE WEST, GEOID 2012 BU ZONE 5.

BEARING AND DISTANCE BETWEEN CONTROL POINT 506526 AND 506524: N82°13'30"E 2110.95'

KIOWA DRAIN CONSTRUCTION &					
NO.	DELTA OR BRG	RADIUS	LENGTH	REMARKS	
С3	Δ=39° 50′ 49″	460.8'	320.48		
C4	Δ=35° 11' 02"	504.8'	309.98'		
L6	N 89°22'02" E		500.53		
L7	S 89°11'43" E		307.18		
L8	N 53°32'22" E		280.71		
L9	N 89°47'05" E		131.45'		
L10	N 89°52'49" E		736.73		






© 2025 KIMLEY—HORN & ASSOCIATES, INC. 1661 E CAMELBACK RD #400, PHOENIX, AZ 85016 PHONE: 602—944—5500 | WWW.KIMLEY—HORN.COM

G^Y 50959 G ZACHARY R. Sheet Number:

Sheet 3 of 11

GEOMETRIC CONTROL SHEET

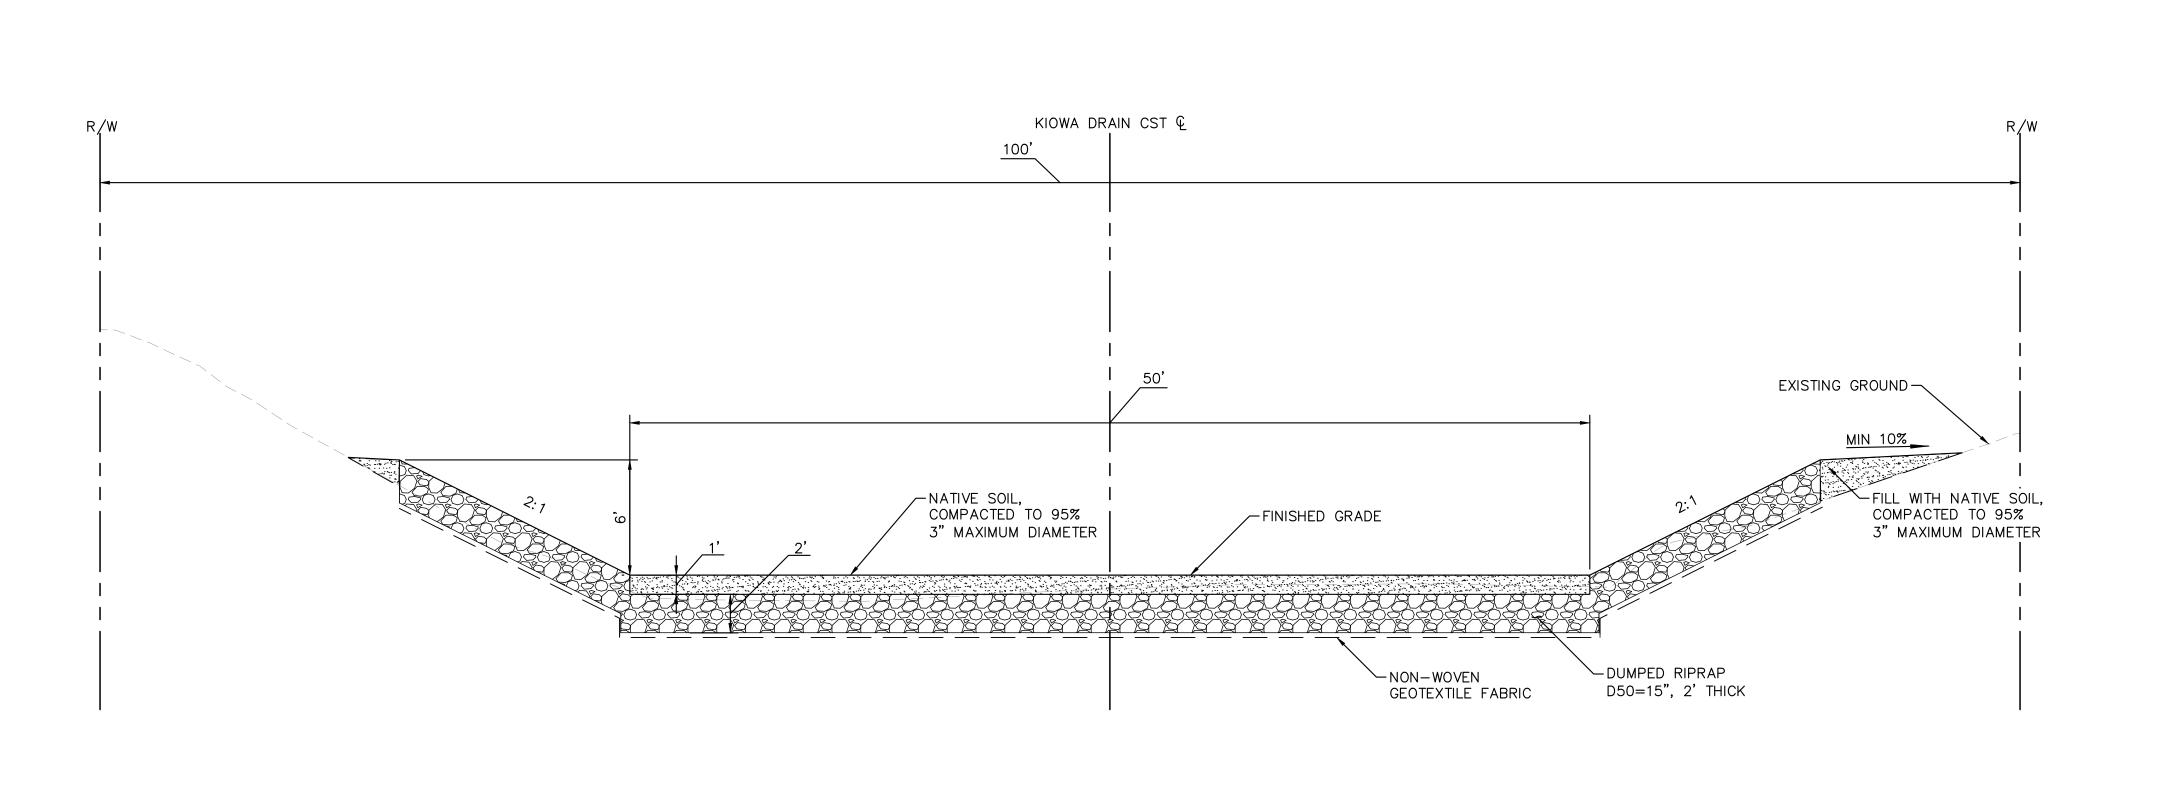



TYPICAL SECTION 1 SCALE: 1" = 5'
STA 16+32 TO STA 21+50
(CONDITIONAL FILL)

NO. ## ## ##

<u>LEGEND</u>



TYPICAL SECTION 1

 $\frac{\text{SCALE: } 1" = 5'}{\text{STA } 16+32 \text{ TO STA } 21+50}$ (CONDITIONAL CUT)

PROPOSED RIPRAP




PROPOSED PLACEMENT OF NATIVE SOIL









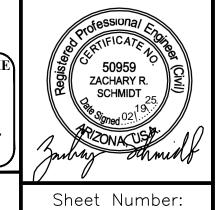

TS01 Sheet 4 of 11

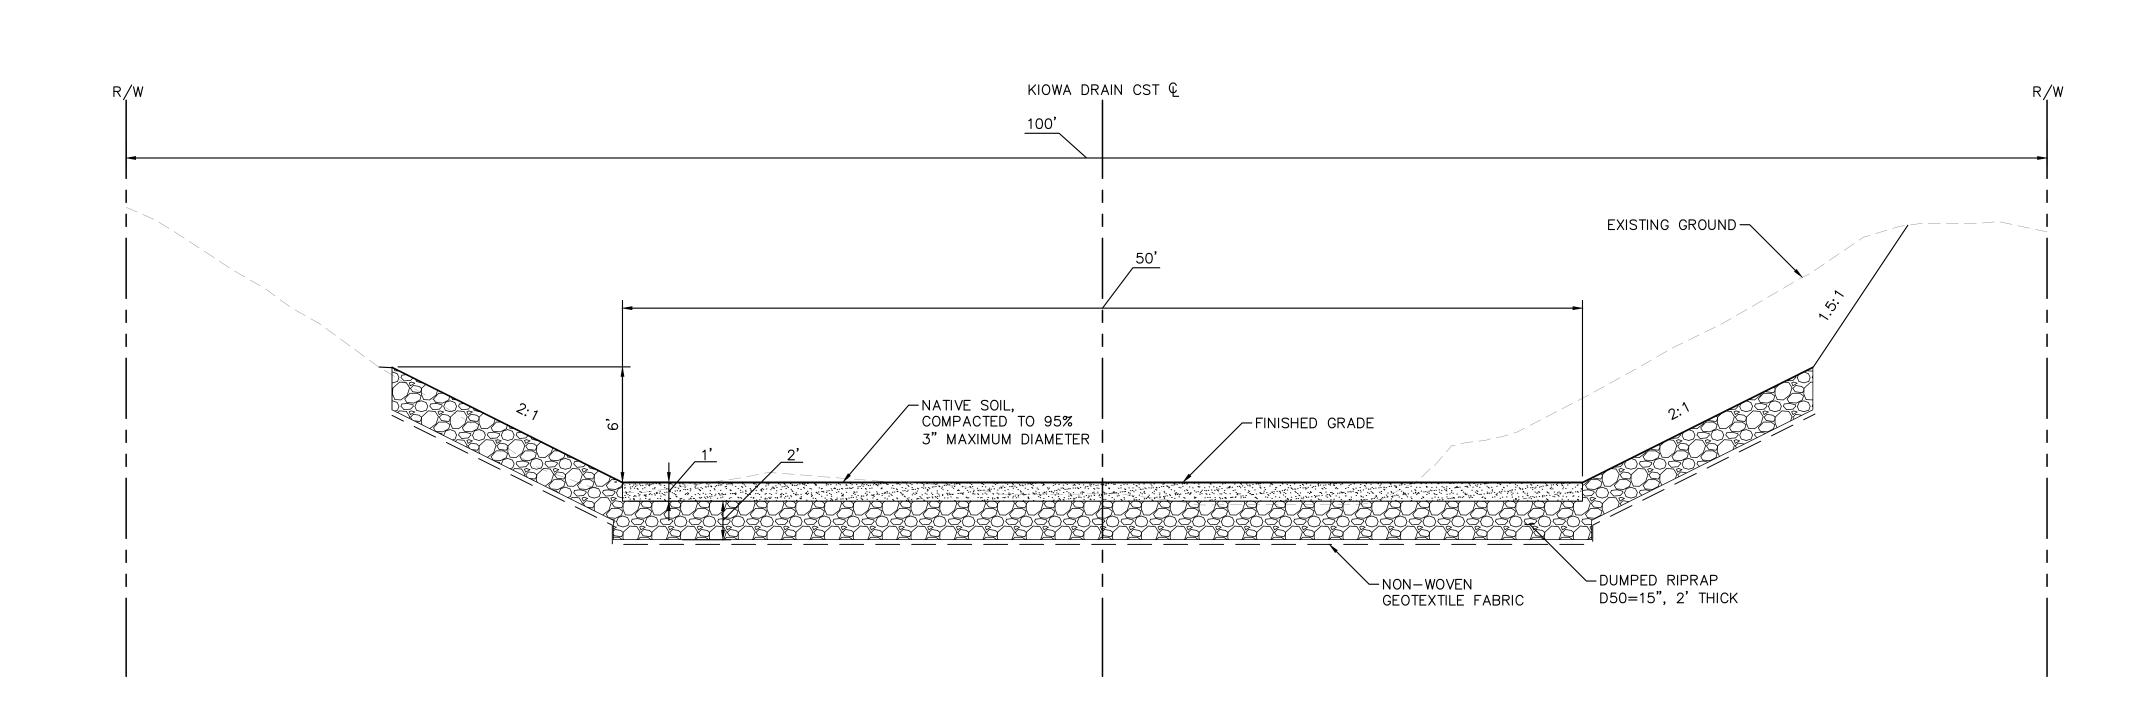

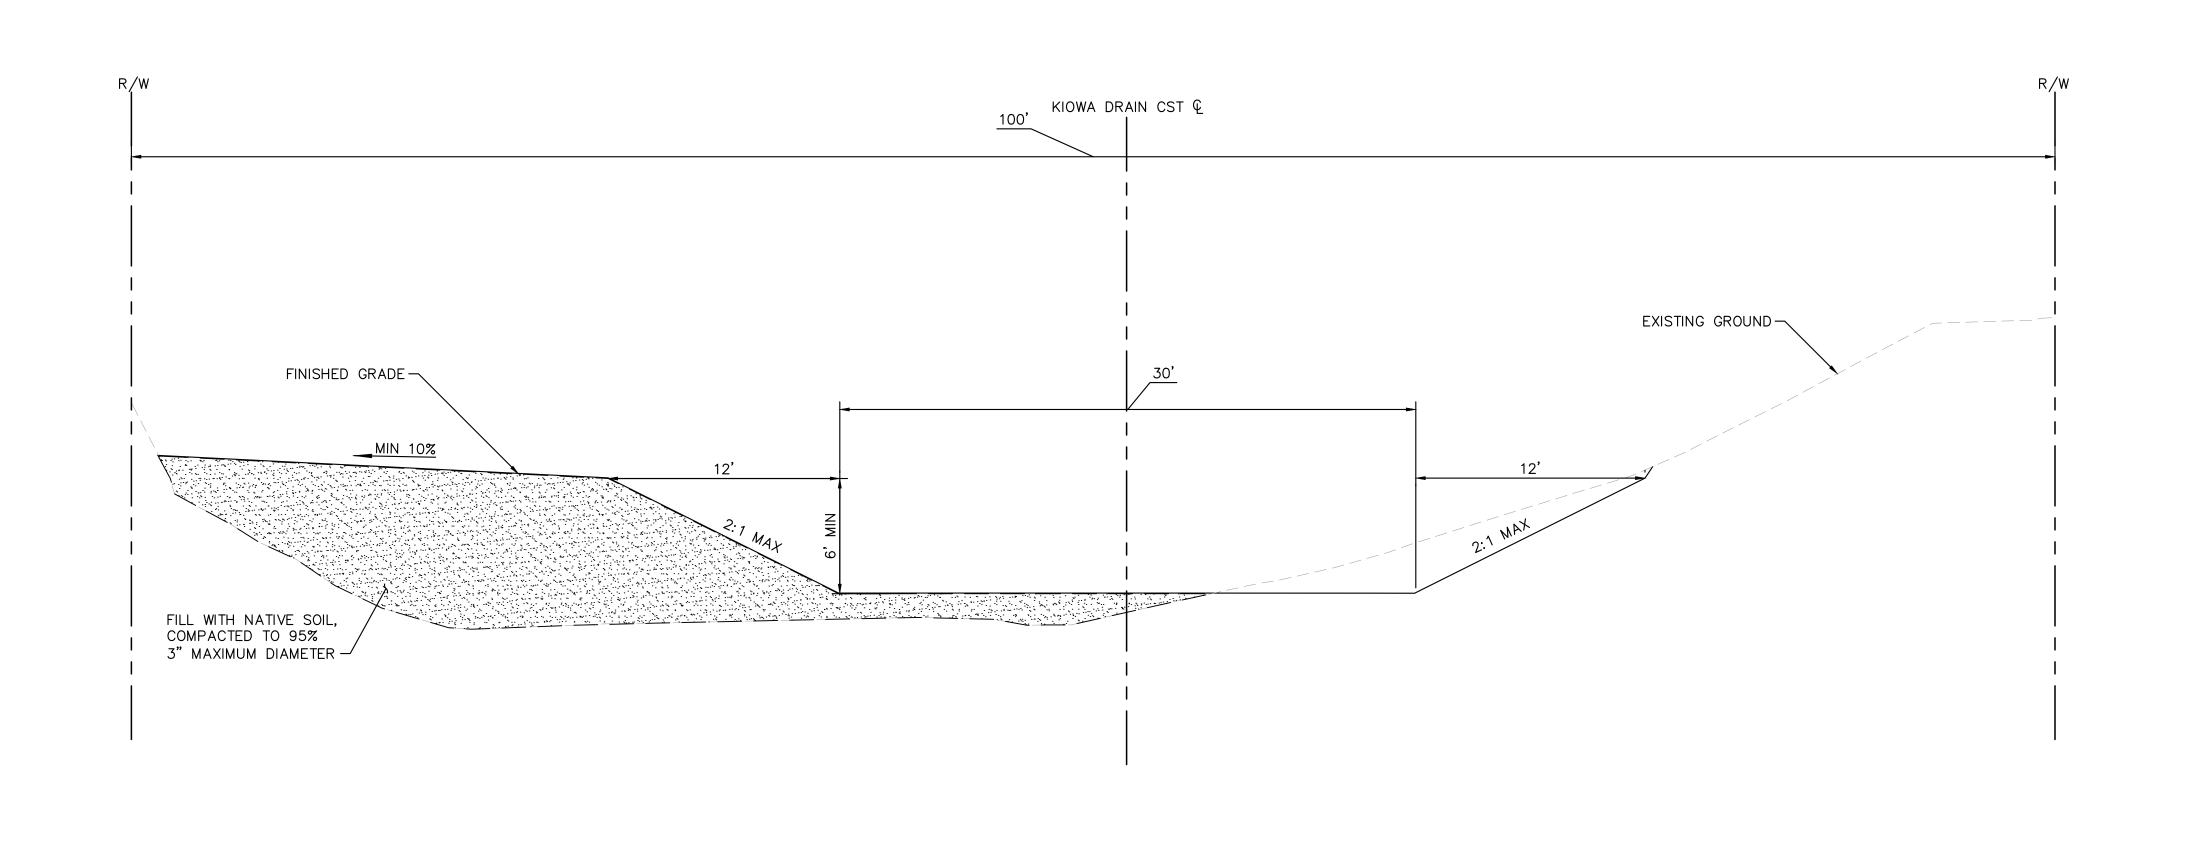




TYPICAL SECTION 2 SCALE: 1" = 5' STA 21+80 TO STA 27+31.48 (CONDITIONAL FILL)

DATE	l	I	I	I
REVISIONS / SUBMISSIONS	_	_	I	l
o.	7	7		7

ON # # # # #


LEGEND

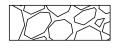

TYPICAL SECTION 2

 $\frac{\text{SCALE: 1"} = 5'}{\text{STA 21+80 TO STA 27+31.48}}$ $\frac{\text{(CONDITIONAL CUT)}}{\text{(CONDITIONAL CUT)}}$

PROPOSED RIPRAP

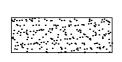


PROPOSED PLACEMENT OF NATIVE SOIL


CONTRACTOR TO CALL BLUE STAKE AND POTHOLE PRIOR TO EXCAVATION





© 2025 KIMLEY-HORN & ASSOCIATES, INC. 1661 E CAMELBACK RD #400, PHOENIX, AZ 85016 PHONE: 602-944-5500 | WWW.KIMLEY-HORN.COM

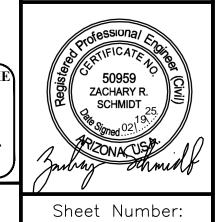



TS02 Sheet 5 of 11

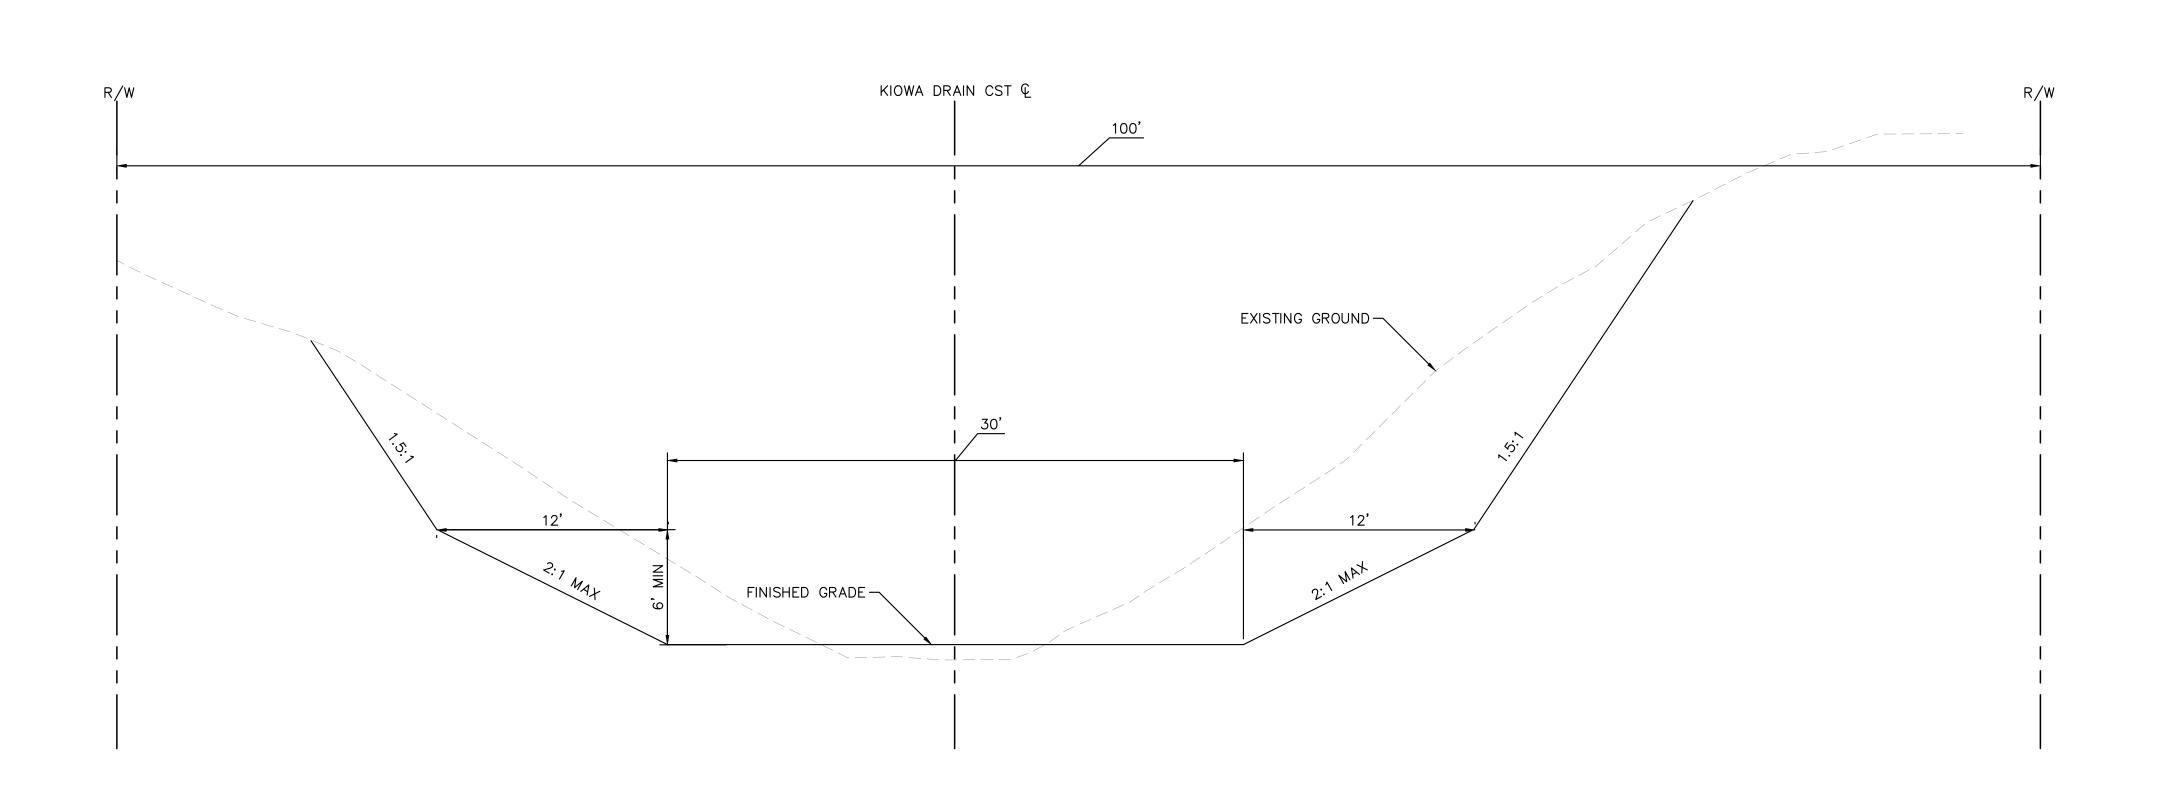

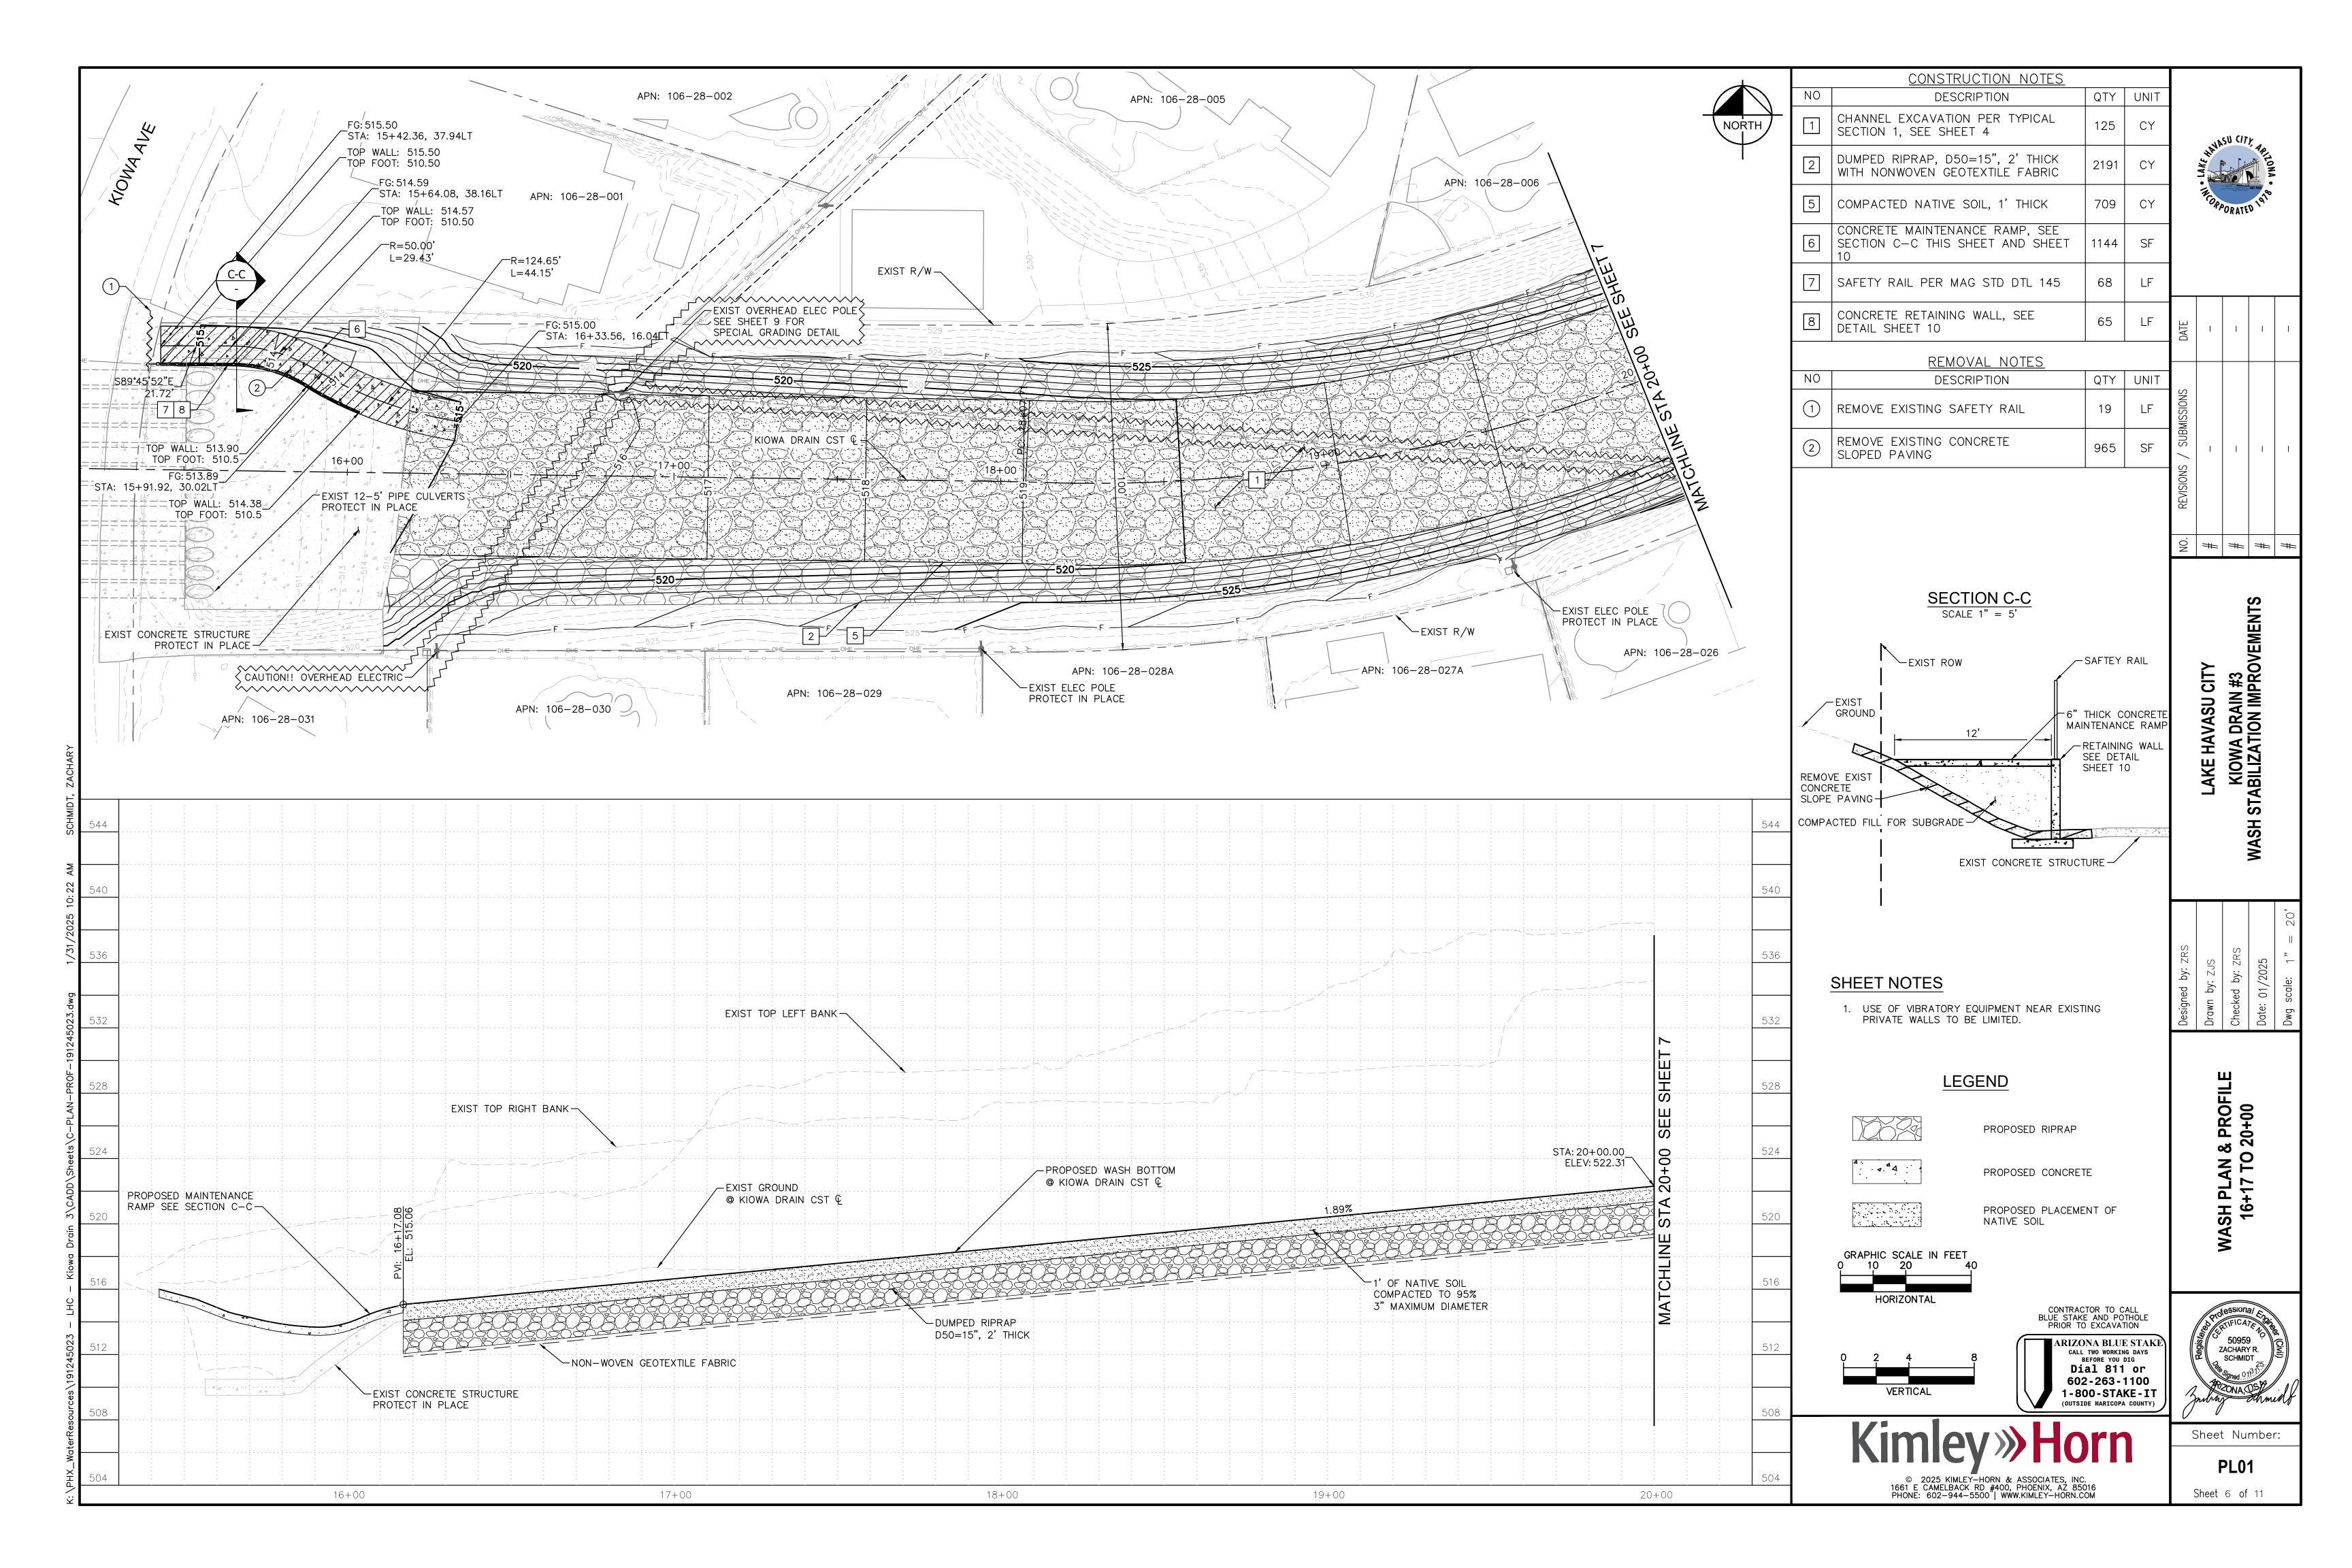

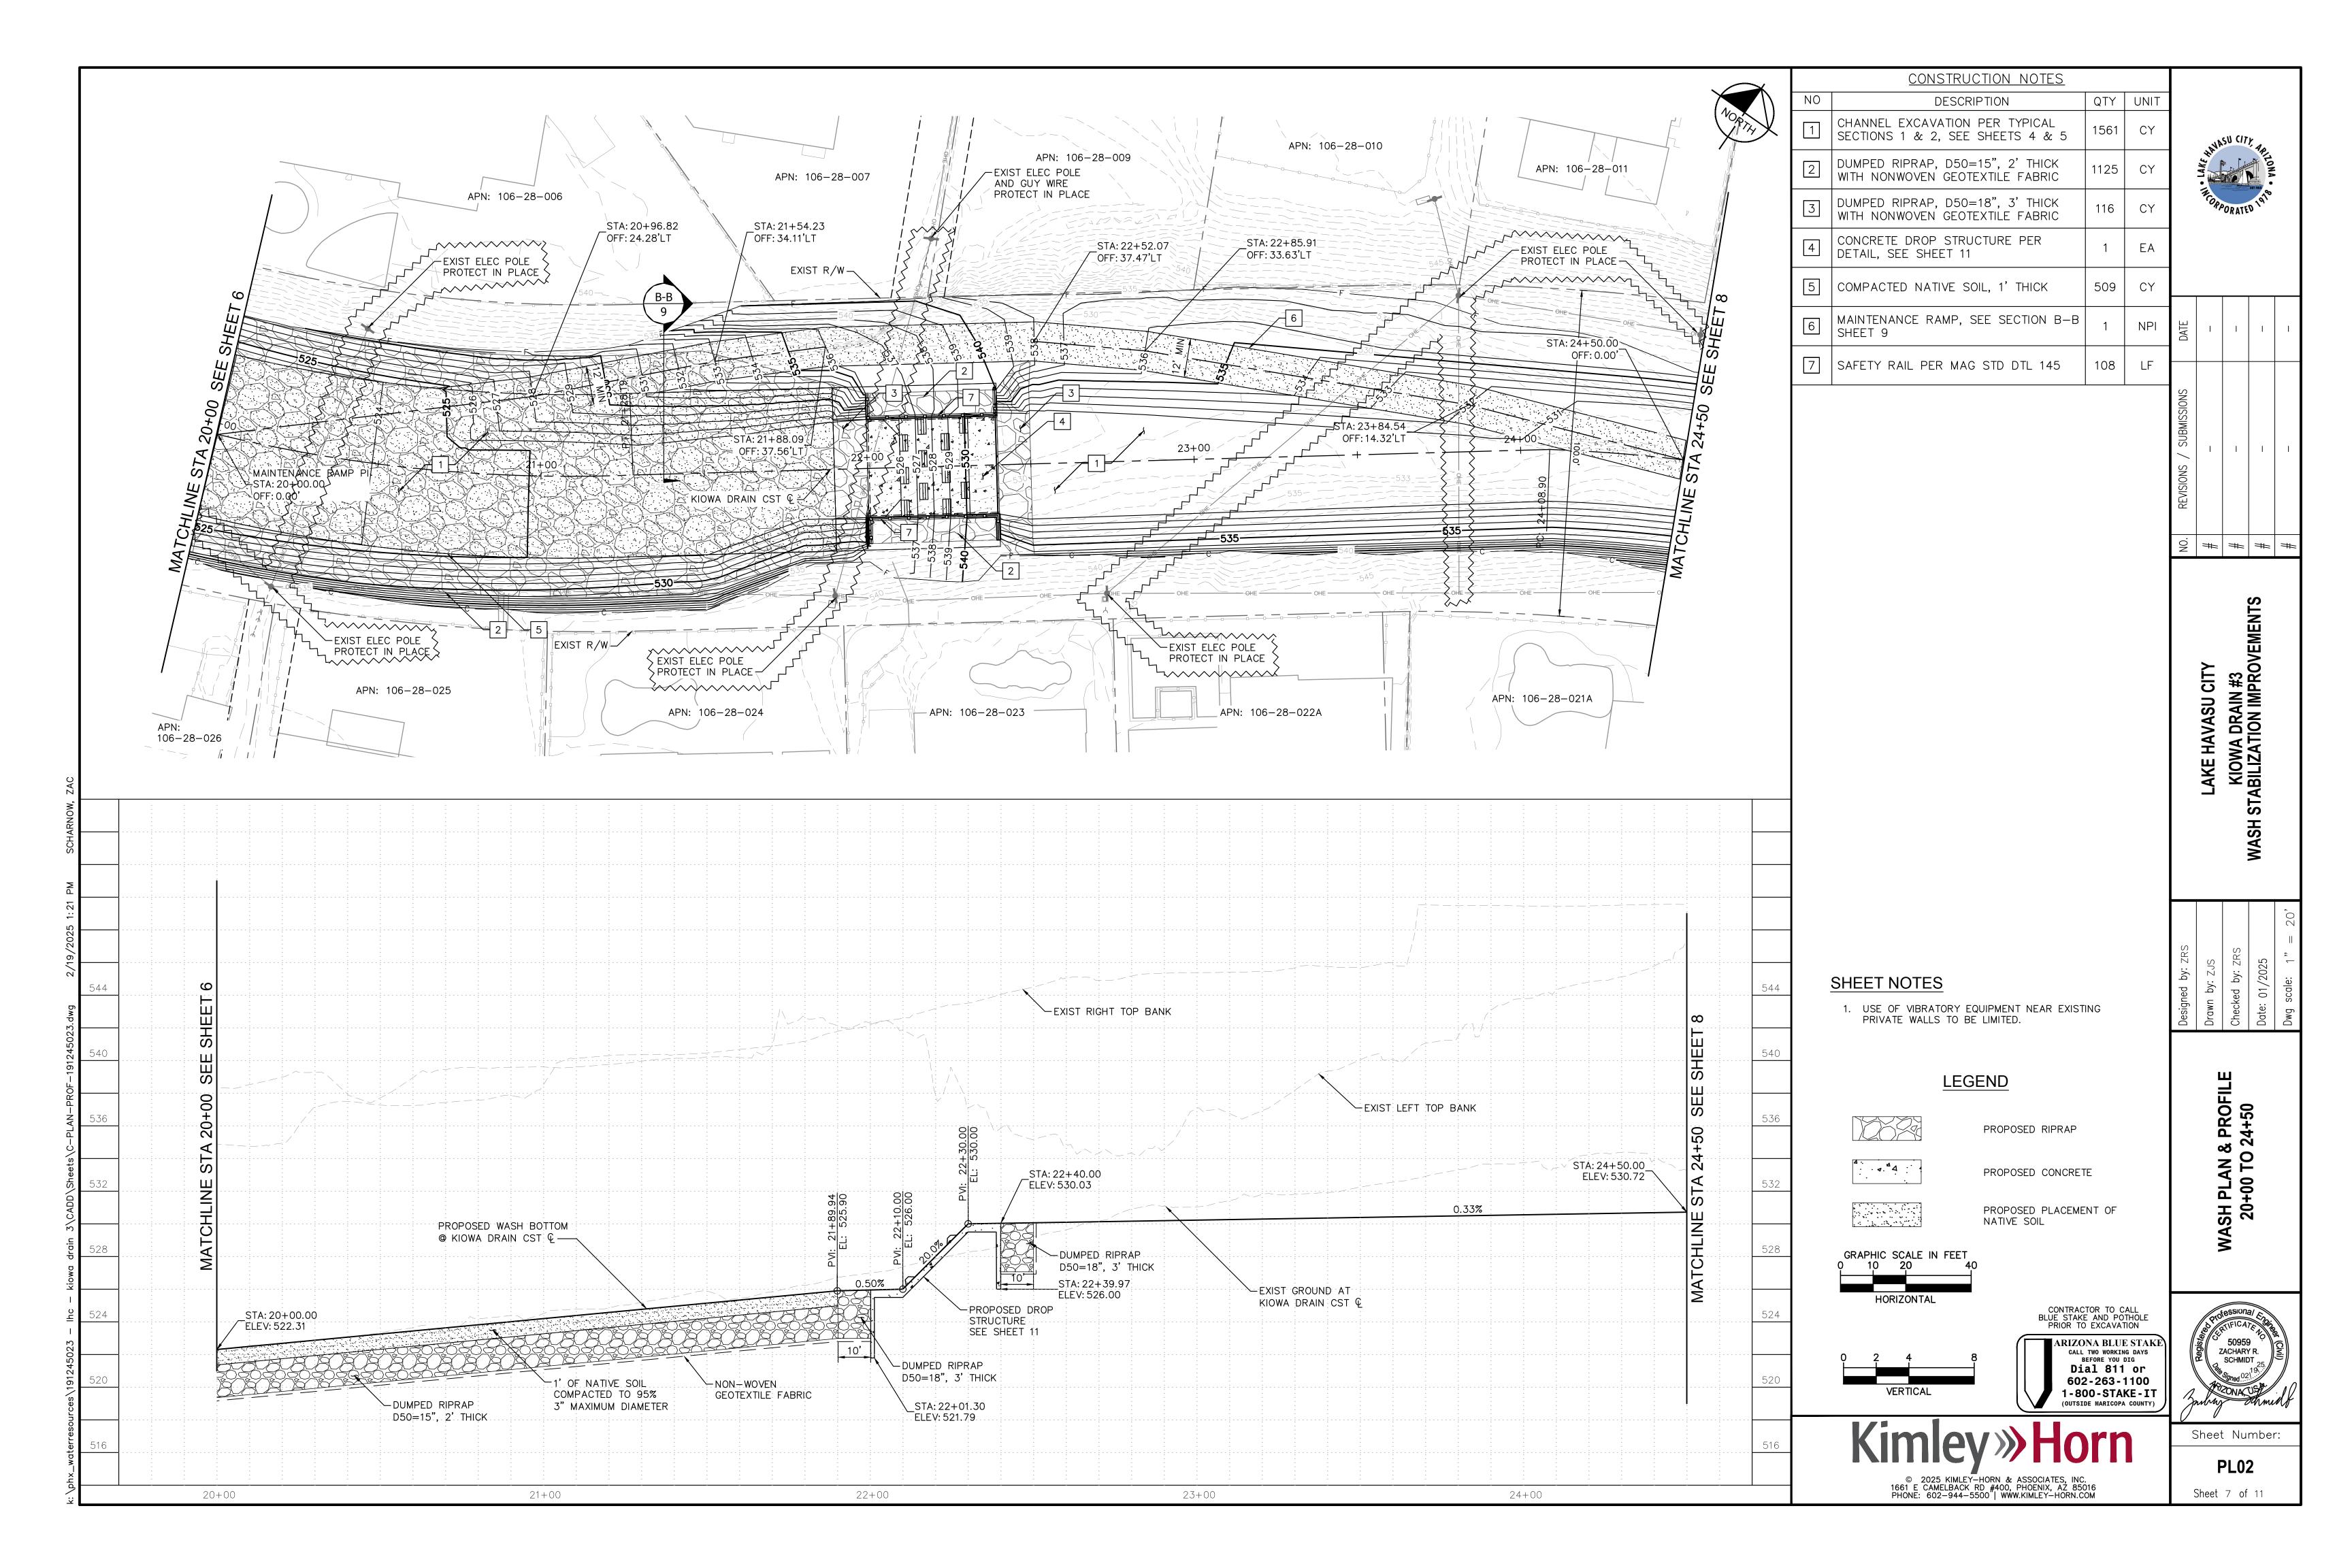

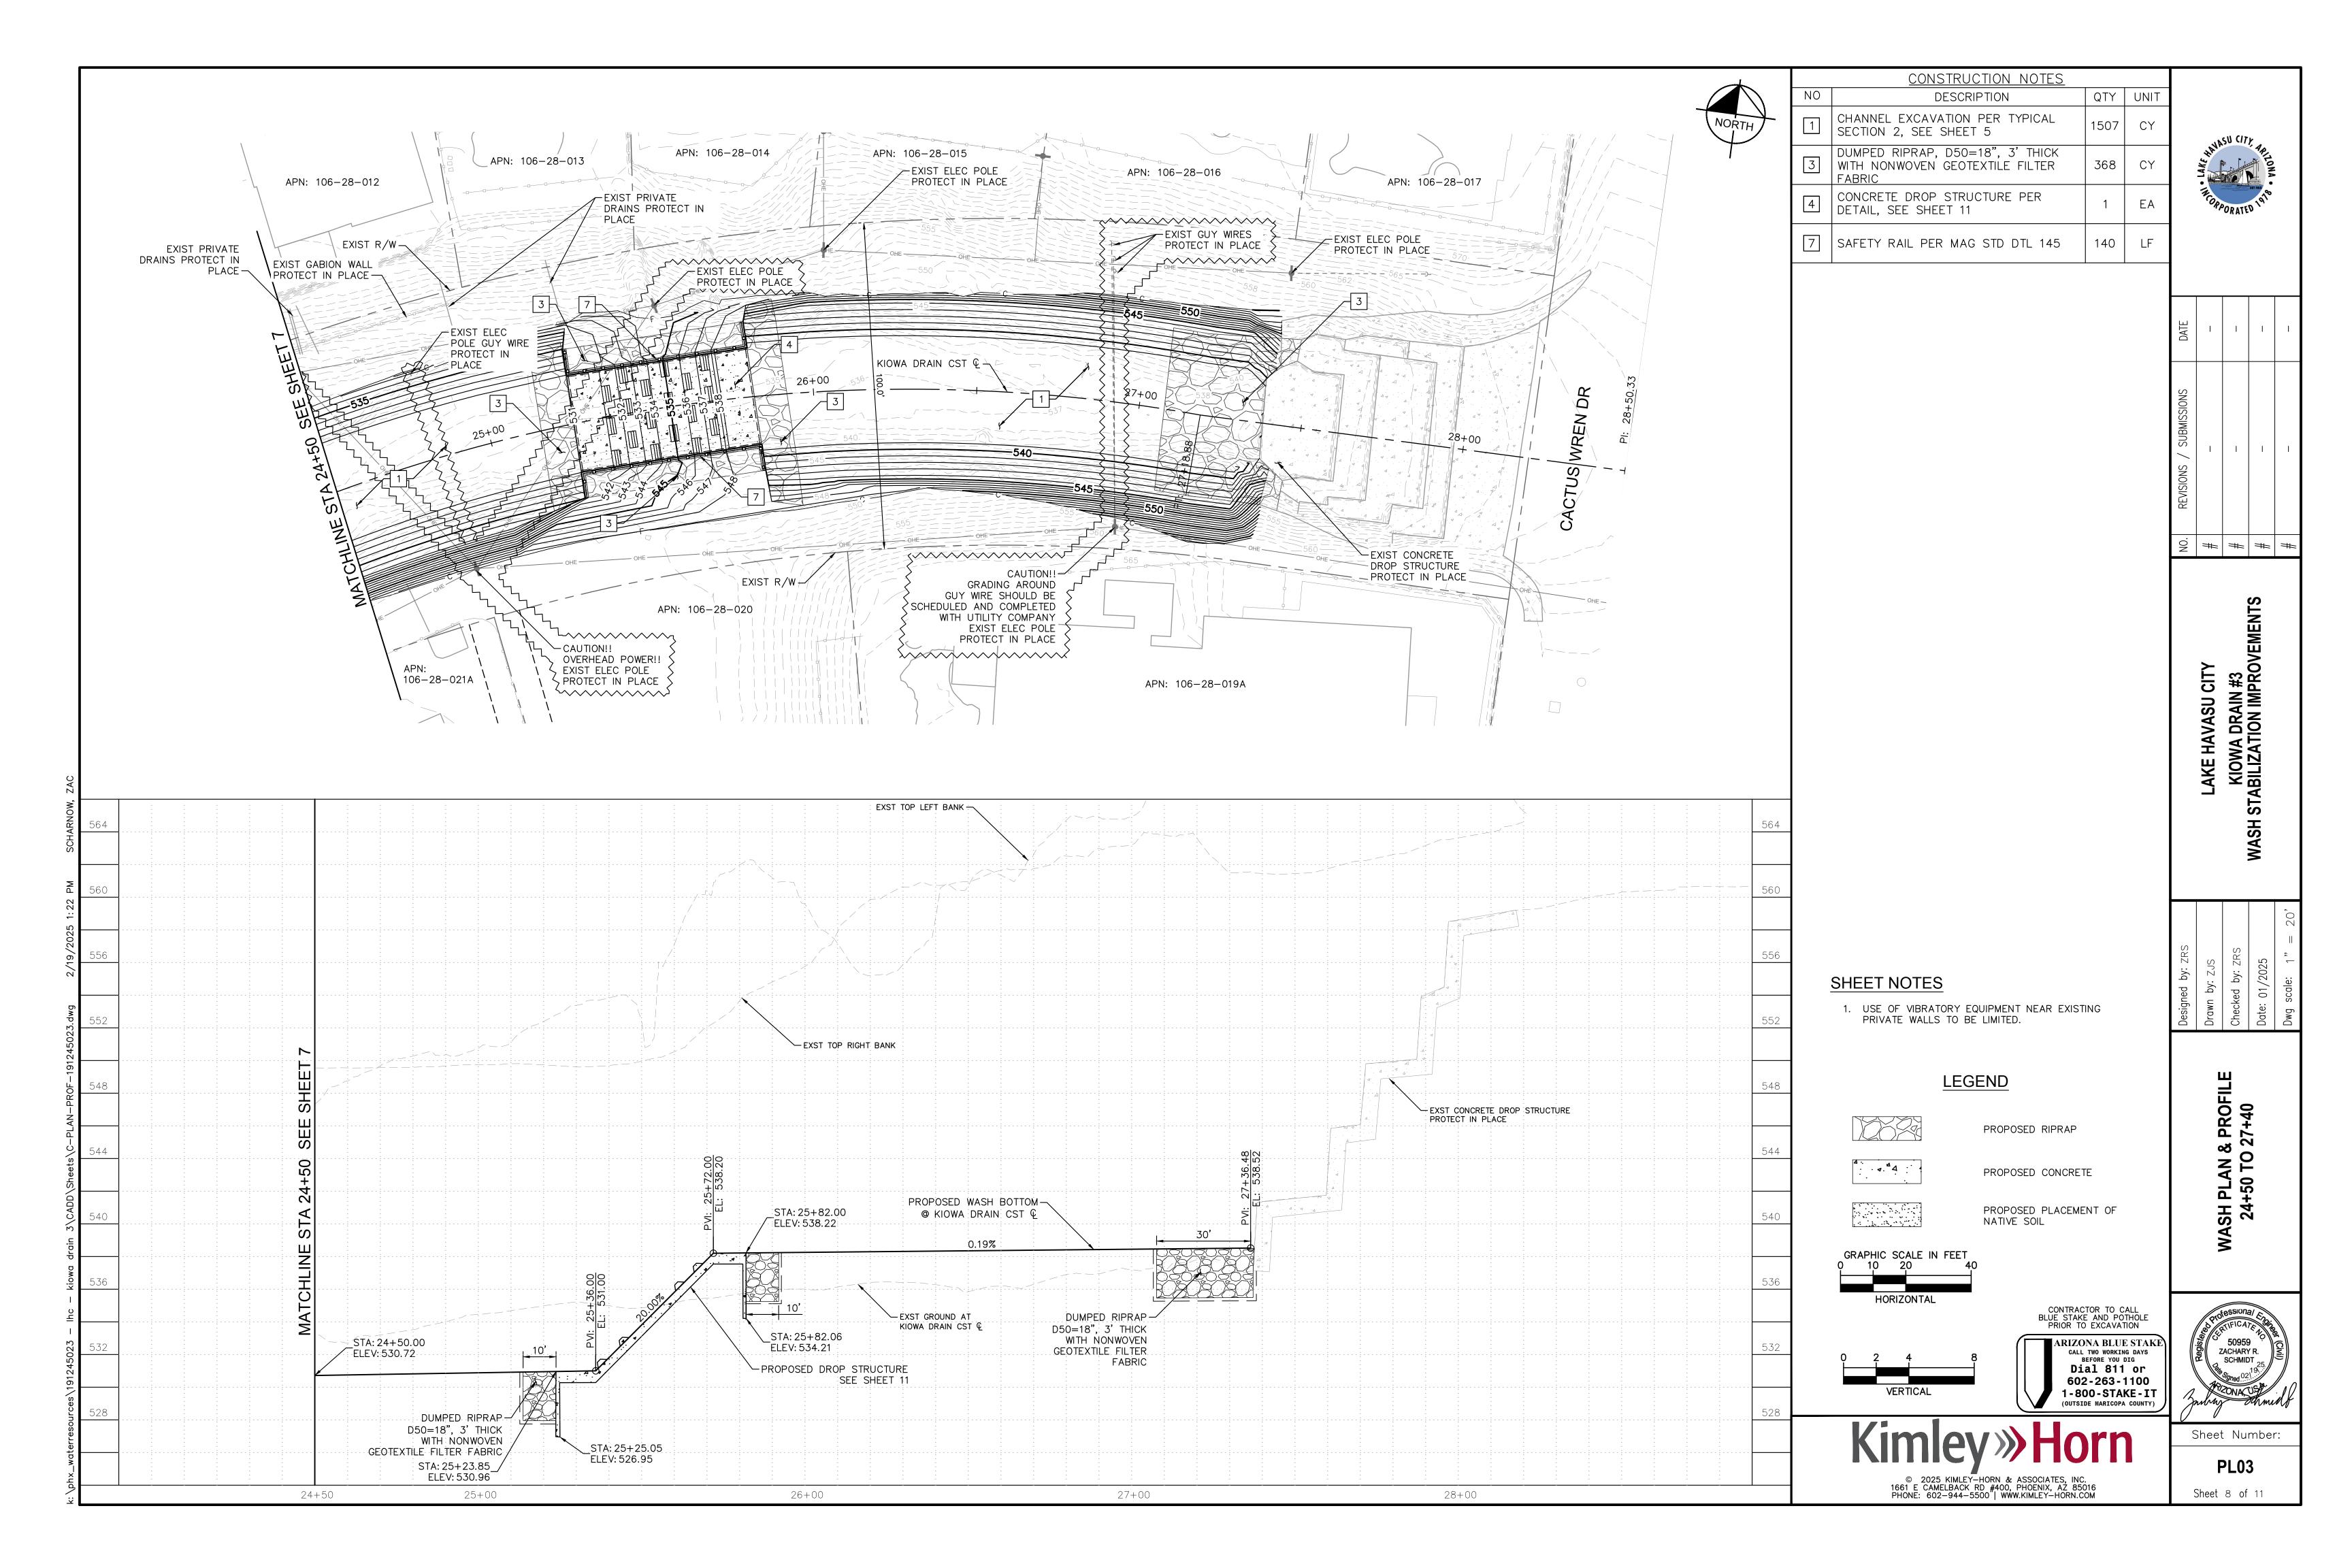

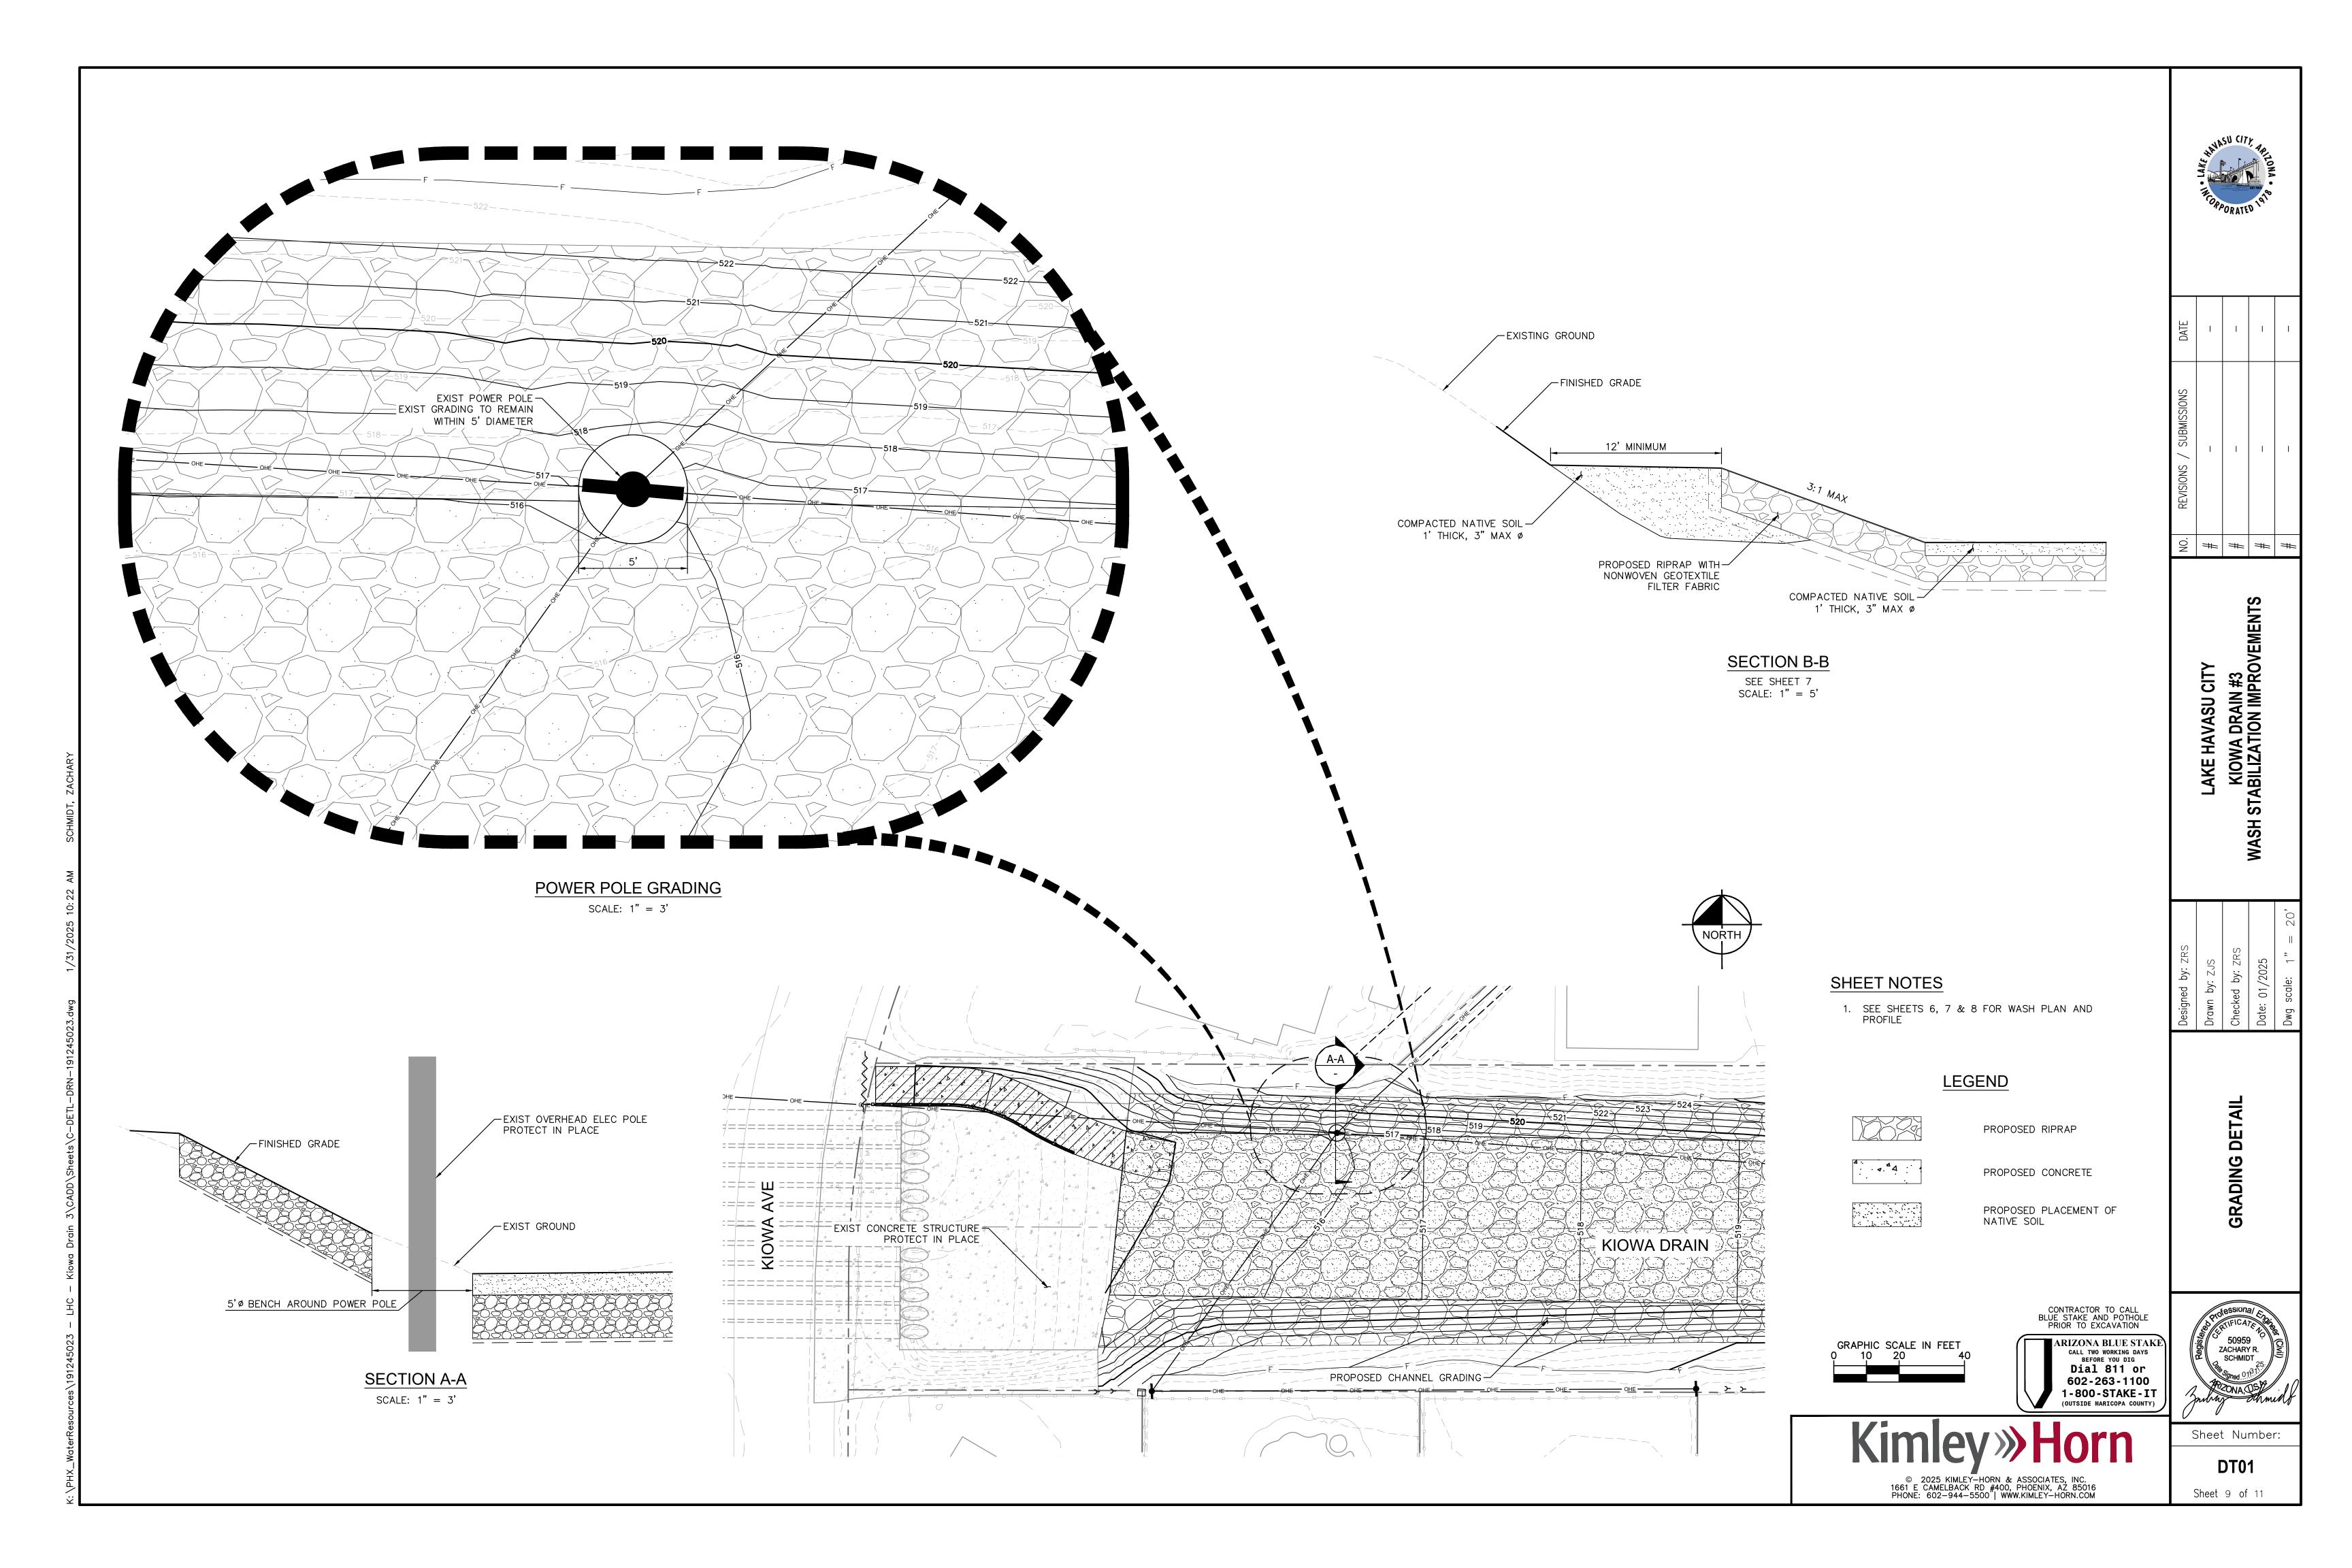

DESIGN SPECIFICATIONS

2018 INTERNATIONAL BUILDING CODE WITH LAKE HAVASU CITY AMENDMENTS.

CONSTRUCTION SPECIFICATIONS

2020 MAG UNIFORM STANDARD SPECIFICATIONS FOR PUBLIC WORKS CONSTRUCTION, 2025 REVISIONS.

DESIGN LOADS

EARTH LOADS:

SOIL INFORMATION IS BASED ON THE 2018 INTERNATIONAL BUILDING CODE (IBC) AND GEOTECHNICAL EVALUATION FOR KIOWA DRAIN 3 WASH STABILIZATION IMPROVEMENTS, KIOWA AVENUE TO CACTUS WREN DRIVE, PREPARED BY NINYO & MOORE, PROJECT NO. 608258001, DATED JANUARY 14, 2025.

WEIGHT OF BACKFILLACTIVE LATERAL EARTH PRESSURE	120 PCF 40 PCF
PASSIVE LATERAL EARTH PRESSURECOEFFICIENT OF FRICTION	360 PCF 0.40
ALLOWABLE SOIL BEARING PRESSURE	2,500 PS
EARTHQUAKE DESIGN DATA:	
l _e	1.00
SITE CLASS	D
S _S	0.24g
S ₁	0.12g
S _{DS}	0.29g
SEISMIC DESIGN CATEGORY	D

CONCRETE AND REINFORCEMENT

CAST-IN-PLACE CONCRETE SHALL BE MAG CLASS A, $f'_{C} = 3,000$ PSI MIN UNLESS NOTED OTHERWISE.

REINFORCING SHALL CONFORM TO ASTM A615, GRADE 60, $f_y = 60,000$ PSI.

HOOKS AND BENDS FOR REINFORCING BARS SHALL CONFORM TO THE REQUIREMENTS OF ACI 318-14.

ALL BEND DIMENSIONS FOR REINFORCING STEEL SHALL BE OUT—TO—OUT OF BARS. ALL PLACEMENT DIMENSIONS FOR REINFORCING STEEL SHALL BE TO CENTER OF BARS UNLESS NOTED OTHERWISE.

ALL REINFORCING SHALL HAVE 2" CLEAR COVER UNLESS NOTED OTHERWISE.

ALL EXPOSED CONCRETE CORNERS SHALL BE CHAMFERED 34".

JOINTS

WALL FOOTINGS MAY BE CONTINUOUS WITHOUT JOINTS.

CONSTRUCTION JOINTS SHALL BE PROVIDED AT INTERVALS NOT TO EXCEED 30'-0".

EXPANSION JOINTS SHALL BE PROVIDED AT INTERVALS NOT TO EXCEED 90'-0".

COORDINATION

CONTRACTOR SHALL COORDINATE ALL EXISTING CONDITIONS DURING CONSTRUCTION OF PROJECT. UTILITY INFORMATION SHOWN ON THE PLANS MAY NOT BE COMPLETE OR ACCURATELY DEPICT THE LOCATION OF THE FACILITIES SHOWN. THE CONTRACTOR SHALL COORDINATE THE LOCATION OF ALL EXISTING, NEW, RELOCATED AND ABANDONED UTILITIES WITH THE PROJECT PLANS AND NOTIFY RESPECTIVE OWNERS BEFORE COMMENCING THE WORK OF EXCAVATION, INCLUDING ANY DRILLING OR PILING REQUIRED FOR TEMPORARY SHORING. CONFLICTS SHALL BE BROUGHT TO THE ATTENTION OF THE ENGINEER AND RESOLVED PRIOR TO PROCEEDING WITH THE WORK. SEE CIVIL AND UTILITY DRAWINGS FOR ADDITIONAL INFORMATION.

VERIFY ALL DIMENSIONS AND ELEVATIONS PRIOR TO STARTING WORK. NOTIFY THE ENGINEER OF ANY DISCREPANCIES.

THE CONTRACTOR SHALL BE RESPONSIBLE FOR PROVIDING TEMPORARY SHORING AS REQUIRED TO MAINTAIN TRAFFIC, TO PROTECT UTILITIES, FOR PROTECTION OF WORKERS, OR AS OTHERWISE NEEDED TO ACCOMPLISH THE WORK. THE CONTRACTOR SHALL SUBMIT A PLAN OUTLINING CONSTRUCTION PROCEDURES, SHORING REQUIREMENTS (COST IS INCLUDED IN OTHER ITEMS), AND DESIGN TO THE ENGINEER FOR REVIEW AND APPROVAL PRIOR TO PROCEEDING WITH THE WORK.

SEE CIVIL PLANS FOR STRUCTURE LOCATION AND LAYOUT INFORMATION.

DIMENSIONS

DIMENSIONS SHALL NOT BE SCALED FROM DRAWINGS.

CONSTRUCTION SPECIFICATIONS

ACI AMERICAN CONCRETE INSTITUTE
ASTM AMERICAN SOCIETY FOR TESTING AND MATERIALS

CLR CLEARANCE
IBC INTERNATIONAL BUILDING CODE

IBC INTERNATI
MAX MAXIMUM

MIN MINIMUM
PCF POUNDS PER CUBIC FOOT

PSF POUNDS PER SQUARE FOOT PSI POUNDS PER SQUARE INCH

TYP TYPICAL VAR VARIES

FOUNDATIONS

FOUNDATION DATA BASED ON GEOTECHNICAL EVALUATION FOR KIOWA DRAIN 3 WASH STABILIZATION IMPROVEMENTS, KIOWA AVENUE TO CACTUS WREN DRIVE, PREPARED BY NINYO & MOORE, PROJECT NO. 608258001, DATED JANUARY 14, 2025.

SPECIAL INSPECTIONS

SPECIAL INSPECTION IS REQUIRED DURING THE FOLLOWING OPERATIONS PER IBC SECTION 1704:

STRUCTURAL CONCRETE. AS REQUIRED BY THE PROJECT SPECIFICATION AND SPECIAL INSPECTION TABLES.

DUTIES AND RESPONSIBILITIES OF THE SPECIAL INSPECTOR:

- 1. THE SPECIAL INSPECTOR SHALL OBSERVE THE WORKED ASSIGNED TO BE CERTAIN IT CONFORMS WITH THE APPROVED DESIGN DRAWINGS AND SPECIFICATIONS.
- 2. THE SPECIAL INSPECTOR SHALL FURNISH INSPECTION REPORTS TO THE BUILDING OFFICIAL, THE ENGINEER OF RECORD, AND OWNER. ALL DISCREPANCIES SHALL BE BROUGHT TO THE IMMEDIATE ATTENTION OF THE CONTRACTOR FOR CORRECTION, THEN, IF UNCORRECTED, TO THE DESIGN AUTHORITY AND THE BUILDING OFFICIAL.
- 3. UPON COMPLETION OF THE ASSIGNED WORK, THE ENGINEER SHALL COMPLETE AND SIGN A FINAL REPORT CERTIFYING THAT TO THE BEST OF HIS KNOWLEDGE, THE WORK IS IN CONFORMANCE WITH THE APPROVED PLANS AND SPECIFICATIONS, AND THE APPLICABLE WORKMANSHIP PROVISIONS OF THE CODE.
- 4. INSPECTIONS SHALL BE PERFORMED BY AN ICC CERTIFIED INSPECTOR EMPLOYED BY THE OWNER/DEVELOPER.
- 5. SPECIAL INSPECTION OF FILL AROUND THE STRUCTURE SHALL BE PROVIDED AT THE FREQUENCY AS NECESSARY TO ENSURE THAT PROPER FILL AND COMPACTION IS ACHIEVED. COMPACTION TEST FOR EACH LIFT SHALL BE TAKEN PER SPECIFICATION ITEM D-571. THE SPECIAL INSPECTOR SHALL SUBMIT A COMPLIANCE REPORT TO THE OWNER/DEVELOPER AND STRUCTURAL ENGINEER DOCUMENTING FILL TYPE AND PLACEMENT PROCEDURE.

DUTIES AND RESPONSIBILITIES OF THE CONTRACTOR:


- 1. FOR INSPECTION OF CONCRETE, BOLTS IN CONCRETE, REINFORCING STEEL, EXPANSION BOLTS, ADHESIVE ANCHORS, AND STRUCTURAL MASONRY, NOTIFY THE SPECIAL INSPECTOR THAT WORK IS READY FOR INSPECTION AT LEAST ONE WORKING DAY (24 HOURS MINIMUM) BEFORE SUCH INSPECTION IS REQUIRED.
- 2. ALL WORK REQUIRING SPECIAL STRUCTURAL INSPECTION SHALL REMAIN ACCESSIBLE AND EXPOSED UNTIL IT IS OBSERVED BY THE SPECIAL STRUCTURAL INSPECTOR.

REQUIRED SPECIAL INSPECTIONS AND TESTS OF CONCRETE CONSTRUCTION (IBC TABLE 1705.3)

TYPE	CONTINUOUS SPECIAL INSPECTION	PERIODIC SPECIAL INSPECTION	REFERENCED STANDARD	IBC REFERENCE
INSPECT REINFORCEMENT, INCLUDING PRESTRESSING TENDONS, AND VERIFY PLACEMENT.	_	Х	ACI 318: CH. 20, 25.2, 25.3, 26.6.1-26.6.3	1908.4
REINFORCING BAR WELDING: A. VERIFY WELDABILITY OF REINFORCING BARS OTHER THAN ASTM A706	_	X	AWS D1.4 ACI 318: 26.6.4	
B. INSPECT SINGLE—PASS FILLET WELDS, MXIMUM 5/6" C. INSPECT ALL OTHER WELDS	- X	× –	.,,,,,,,,,,,,,,,,,,,,,,,,,,,,,,,,,,,,,,	
INSPECT ANCHORS CAST IN CONCRETE.	_	Х	ACI 318: 17.8.2	_
INSPECT ANCHORS POST—INSTALLED IN HARDENED CONCRETE MEMBERS. A. ADHESIVE ANCHORS INSTALLED IN HORIZONTALLY	Х	_	ACI 318:17.8.2.4	_
OR UPWARDLY INCLINED ORIENTATIONS TO RESIST SUSTAINED TENSION LOADS. B. MECHANICAL ANCHORS AND ADHESIVE ANCHORS NOT DEFINED IN 4.A.	_	X	ACI 318: 17.8.2	
VERIFY USE OF REQUIRED DESIGN MIX.	_	Х	ACI 318: CH. 19, 26.4.3, 26.4.4	1904.1, 1904.2, 1908.2, 1908.3
PRIOR TO CONCRETE PLACEMENT, FABRICATE SPECIMENS FOR STRENGTH TESTS, PERFORM SLUMP & AIR CONTENT TESTS, & DETERMINE THE TEMP. OF THE CONCRETE.	Х	_	ASTM C172, ASTM C31, ACI 318: 26.5, 26.12	1908.10
INSPECT CONCRETE AND SHOTCRETE PLACEMENT FOR PROPER APPLICATION TECHNIQUES.	×	_	ACI 318: 26.5	1908.6, 1908.7, 1908.8
INSPECT FORMWORK FOR SHAPE, LOCATION AND DIMENSIONS OF THE CONCRETE MEMBER BEING FORMED.	_	X	ACI 318: 26.11.1.2(b)	_

REQUIRED SPECIAL INSPECTIONS AND TESTS OF SOILS (IBC TABLE 1705.6)

TYPE	CONTINUOUS SPECIAL INSPECTION	PERIODIC SPECIAL INSPECTION
1. VERIFY MATERIALS BELOW SHALLOW FOUNDATIONS ARE ADEQUATE TO ACHIEVE THE DESIGN BEARING CAPACITY.	-	X
2. VERIFY EXCAVATIONS ARE EXTENDED TO PROPER DEPTH AND HAVE REACHED PROPER MATERIAL.	-	Х
3. PERFORM CLASSIFICATION AND TESTING OF COMPACTED FILL MATERIALS.	_	X
4. VERIFY USE OF PROPER MATERIALS, DENSITIES AND LIFT THICKNESSES DURING PLACEMENT AND COMPACTION OF COMPACTED FILL.	X	_
5. PRIOR TO PLACEMENT OF COMPACTED FILL, INSPECT SUBGRADE AND VERIFY THAT SITE HAS BEEN PREPARED PROPERLY.	-	X

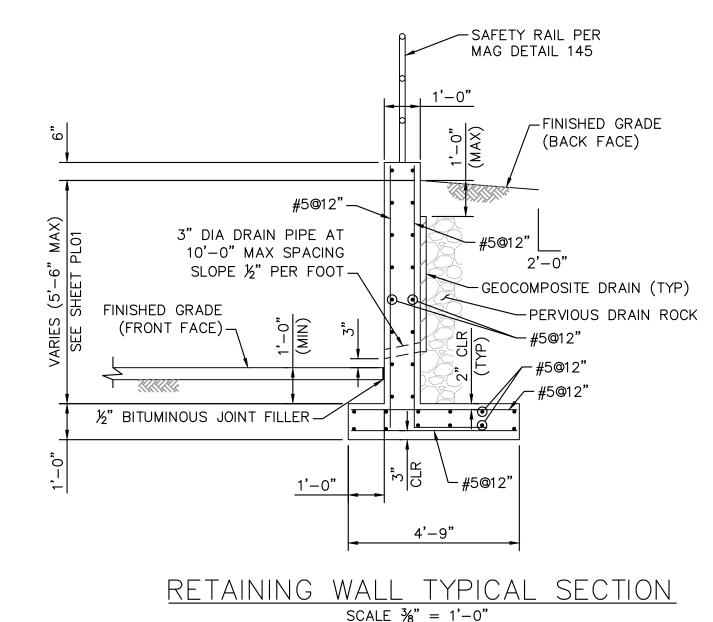



 NO.
 REVISIONS / SUBMISSIONS
 DATE

 #

 #

 #

 #

 #

LAKE HAVASU CITY KIOWA DRAIN #3

Drawn by: MSK
Checked by: NLM
Date: 01/2025
Dwg scale: AS SHOWN

RUCTURE NOTES AN





© 2025 KIMLEY-HORN & ASSOCIATES, INC.
1661 E CAMELBACK RD #400, PHOENIX, AZ 85016
PHONE: 602-944-5500 WWW.KIMLEY-HORN.COM

Sheet Number:

ST01

Sheet 10 of 11

